

TOWN OF WALKERSVILLE

FREDERICK COUNTY, MARYLAND

STORMWATER BMP IMPROVEMENTS

DEERFIELD BMP RETROFIT

UNDERGROUND UTILITY LINE PROTECTION ACT

THE EXISTENCE AND LOCATION OF UNDERGROUND UTILITIES OR STRUCTURES ARE SHOWN IN AN APPROXIMATE WAY ONLY. THE CONTRACTOR SHALL DETERMINE THE EXACT LOCATION OF ALL EXISTING UTILITIES AND STRUCTURES BEFORE COMMENCING THE WORK. CALL MISS UTILITY AT 1-800-257-7777 AT LEAST 48 HOURS IN ADVANCE OF WORK.



PROJECT SUMMARY

THE TOWN OF WALKERSVILLE IS PROPOSING TO REDESIGN AND RETROFIT AN EXISTING SWALE INTO A DRY SWALE LOCATED IN FREDERICK COUNTY. THE PROJECT WILL DECREASE NUTRIENT AND SEDIMENT LOADS AND THE TOWN OF WALKERSVILLE WILL RECEIVE CREDITS TOWARDS THEIR CHESAPEAKE BAY POLLUTION REDUCTION PLAN. THE RETROFIT WILL INVOLVE REGRADING THE SWALE, REPLACING RIP RAP, INSTALLING A PVC UNDERDRAIN WITH CLEANOUTS, PERMEABLE SOILS, AND SEDIMENT FOREBAY INSTALLATIONS. FLOW IS EXPECTED TO LEAVE THE SITE IN A SIMILAR PATTERN TO EXISTING CONDITIONS AND FLOWS TOWARD ISRAEL CREEK.

DISTURBED AREA QUANTITY

THE TOTAL AREA TO BE DISTURBED SHOWN ON THESE PLANS HAS BEEN DETERMINED TO BE APPROXIMATELY 0.739 ACRES (32,171 S.F.) AND THE TOTAL AMOUNT OF EXCAVATION AND FILL AS SHOWN ON THESE PLANS HAS BEEN COMPUTED TO BE APPROXIMATELY 1,775 CUBIC YARDS OF EXCAVATION AND APPROXIMATELY 153 CUBIC YARDS OF FILL. (APPROX. ONLY - NOT FOR BID PURPOSES) CUT AND FILL ARE TRENCH EXCAVATION AND BACKFILL ONLY.

Edward Van Arsdale 1/4/24
 EDWARD VAN ARSDALE, PE DATE
 MD. PE NO. 38561

ENGINEER/ARCHITECT DESIGN CERTIFICATION

I HEREBY CERTIFY THAT THE PLANS HAVE BEEN DESIGNED IN ACCORDANCE WITH LOCAL ORDINANCES, COMAR 26.17.01, AND 2011 MARYLAND STANDARDS AND SPECIFICATIONS FOR SOIL EROSION AND SEDIMENT CONTROL.

Edward Van Arsdale 1/4/24
 EDWARD VAN ARSDALE, PE DATE
 MD. PE NO. 38561

DESIGN CERTIFICATION

I HEREBY CERTIFY THAT THIS PLAN HAS BEEN PREPARED IN ACCORDANCE WITH THE "STANDARDS AND SPECIFICATIONS FOR SOIL EROSION AND SEDIMENT CONTROL IN DEVELOPING AREA" AND THE REQUIREMENTS OF THE FREDERICK SOIL CONSERVATION DISTRICT.

Edward Van Arsdale 1/4/24
 EDWARD VAN ARSDALE, PE DATE
 MD. PE NO. 38561

OWNERS/DEVELOPERS CERTIFICATION

I CERTIFY THAT THIS PLAN OF SEDIMENT CONTROL WILL BE IMPLEMENTED TO THE FULLEST EXTENT, AND ALL STRUCTURES WILL BE INSTALLED TO THE DESIGN AND SPECIFICATIONS AS SPELLED OUT IN THIS PLAN AND THAT ANY RESPONSIBLE PERSONNEL INVOLVED IN THE CONSTRUCTION PROJECT WILL HAVE A CERTIFICATION OF ATTENDANCE AT A DEPARTMENT OF ENVIRONMENT APPROVED TRAINING PROGRAM FOR THE CONTROL OF SEDIMENT AND EROSION BEFORE BEGINNING THE PROJECT. I ALSO AUTHORIZE PERIODIC ON-SITE EVALUATION BY THE CATOCIN/FREDERICK SOIL CONSERVATION DISTRICT PERSONNEL AND COOPERATING AGENCIES.

XX

XX

DRAWING INDEX

- 1 OF 9 DEERFIELD BMP RETROFIT TITLE SHEET
- 2 OF 9 DEERFIELD BMP RETROFIT EXISTING CONDITIONS STA 0+00 TO STA 5+50
- 3 OF 9 DEERFIELD BMP RETROFIT EXISTING CONDITIONS STA 5+50 TO STA 9+72
- 4 OF 9 DEERFIELD BMP RETROFIT PROPOSED CONDITIONS STA 0+00 TO STA 5+50
- 5 OF 9 DEERFIELD BMP RETROFIT PROPOSED CONDITIONS STA 5+50 TO STA 9+72
- 6 OF 9 DEERFIELD BMP RETROFIT EROSION AND SEDIMENT CONTROL PLAN
- 7 OF 9 DEERFIELD BMP RETROFIT DESIGN DETAILS
- 8 OF 9 DEERFIELD BMP RETROFIT EROSION AND SEDIMENT CONTROL DETAILS
- 9 OF 9 DEERFIELD BMP RETROFIT EROSION AND SEDIMENT CONTROL NOTES

GENERAL NOTES

1. DURING THE LAYOUT OF SEDIMENT CONTROL PRACTICES REQUIRED ON THIS PLAN, MINOR FIELD ADJUSTMENTS CAN AND WILL BE MADE TO INSURE THE ARREST AND CONTROL OF ANY SEDIMENT BEFORE IT LEAVES THE CONSTRUCTION SITE. CHANGES IN SEDIMENT CONTROL PRACTICES REQUIRE PRIOR APPROVAL OF THE SEDIMENT CONTROL INSPECTOR.
2. THE CONTRACTOR WILL BE RESPONSIBLE FOR INSTALLING SEDIMENT RETENTION STRUCTURES, AND SURFACE WATER DIVERSIONS AS PART OF THE INITIAL PHASE OF CONSTRUCTION.
3. PREVENT THE TRACKING OF MUD FROM THE SITE ONTO PUBLIC ROADS BY PLACING CRUSHED STONE OVER EGRESS AREA OR BY EFFECTIVE MEANS. ALSO RESPONSIBLE FOR THE IMMEDIATE REPAIR OF ANY DAMAGE TO PUBLIC OR PRIVATE ROADS CAUSED BY THIS CONSTRUCTION.
4. CONTINUAL INSPECTION AND MAINTENANCE OF SEDIMENT CONTROL FACILITIES SHALL BE PERFORMED UNTIL PERMISSION FOR THEIR REMOVAL HAS BEEN OBTAINED FROM THE SOIL CONSERVATION DISTRICT INSPECTOR.
5. NO WORK SHALL PROCEED IN THE STREAM (CLASS IV) CHANNEL DURING STREAM CLOSURE DATES FROM MARCH 1 THRU MAY 31.
6. DEPENDING ON SITE CONDITIONS, PHASING OR CONSTRUCTION SEQUENCING, AND STABILIZATION METHODS, ADDITIONAL SEDIMENT CONTROLS (OTHER THAN AS SHOWN HEREON) MAY BE REQUIRED BY THE INSPECTOR.
7. NO FEMA FLOODPLAINS OR WETLANDS WERE LOCATED ON SITE.

FREDERICK SOIL CONSERVATION DISTRICT
 Erosion And Sediment Control Plan Approval

By: _____
 District Manager or Designee
 Date: _____
 Plan is valid for 2 years from date of approval

SCD APPROVAL FOR SEDIMENT AND EROSION CONTROL IS IN ACCORDANCE WITH THE 2011 MARYLAND STANDARDS AND SPECIFICATION FOR SOIL SOIL EROSION AND SEDIMENT CONTROL AND IS CONTINGENT UPON ISSUANCE OF APPLICABLE REGULATORY PERMITS.


File #: WALKERSVILLE
 A/P #: xx
 Due Date: _____

TOWN OF WALKERSVILLE PLANNING COMMISSION


APPROVED

SUSAN HAUVER - TOWN PLANNER DATE


PROJECT LOCATION

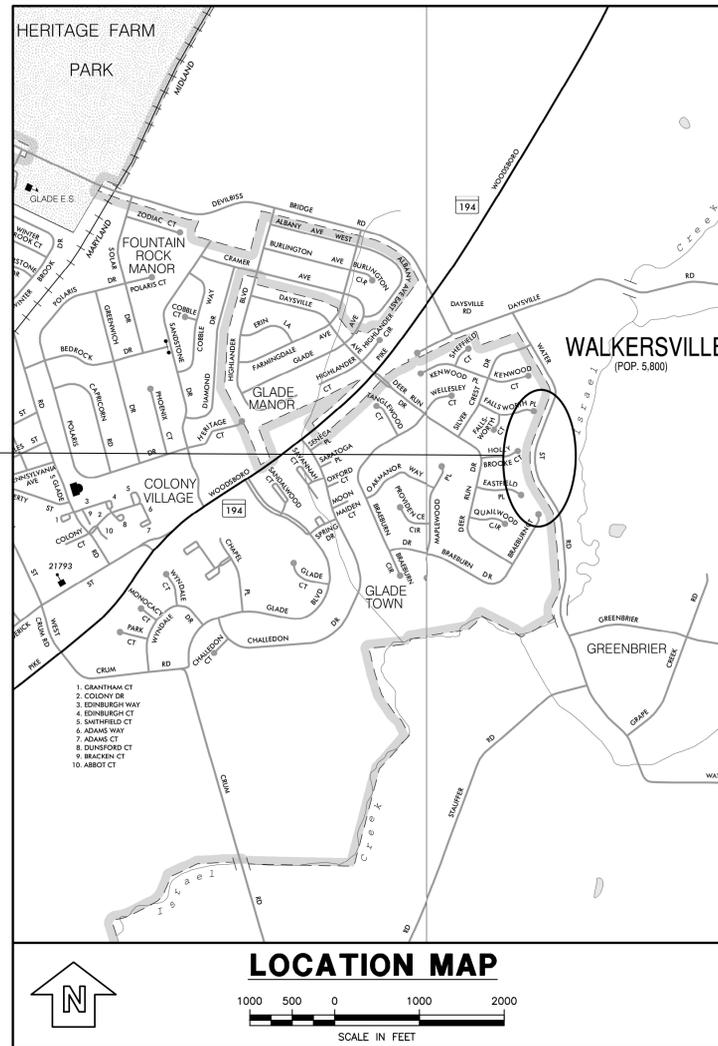

LOCATION MAP

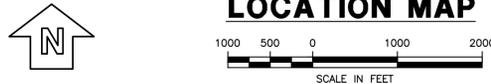

				EDWARD J. VAN ARSDALE, PE RELEASED BY: _____ DESIGN: BCU CHECKED: _____ DRAWN: CADD CHECKED: _____ DATE: JANUARY 2023 SURVEY DATE: DECEMBER 2022 FIELD BOOK: WEBER SURVEYORS				SEAL 				SEAL PROFESSIONAL CERTIFICATION I, EDWARD JOSEPH VAN ARSDALE, III, P.E., hereby certify that these documents were prepared or approved by me, and that I am a duly licensed professional engineer under the laws of the State of Maryland, License No. 38561, Expiration Date: 3/31/2024				CLIENT & PROJECT TOWN OF WALKERSVILLE 21 WEST FREDERICK STREET WALKERSVILLE, MARYLAND 21793 BMP DESIGNS WALKERSVILLE, FREDERICK COUNTY, MARYLAND				201 Thomas Johnson Drive Suite 207 Frederick, MD 21702 Tel 301.791.1100				TITLE: DEERFIELD BMP RETROFIT TITLE SHEET SCALE: AS SHOWN PROJECT NO.: 10827.37 SHEET NO.: 1 OF 9 REV.: _____ DWG. NO.: S-1			
NO	REVISION	DATE	BY	APP.	NO	REVISION	DATE	BY	APP.	NO	REVISION	DATE	BY	APP.													

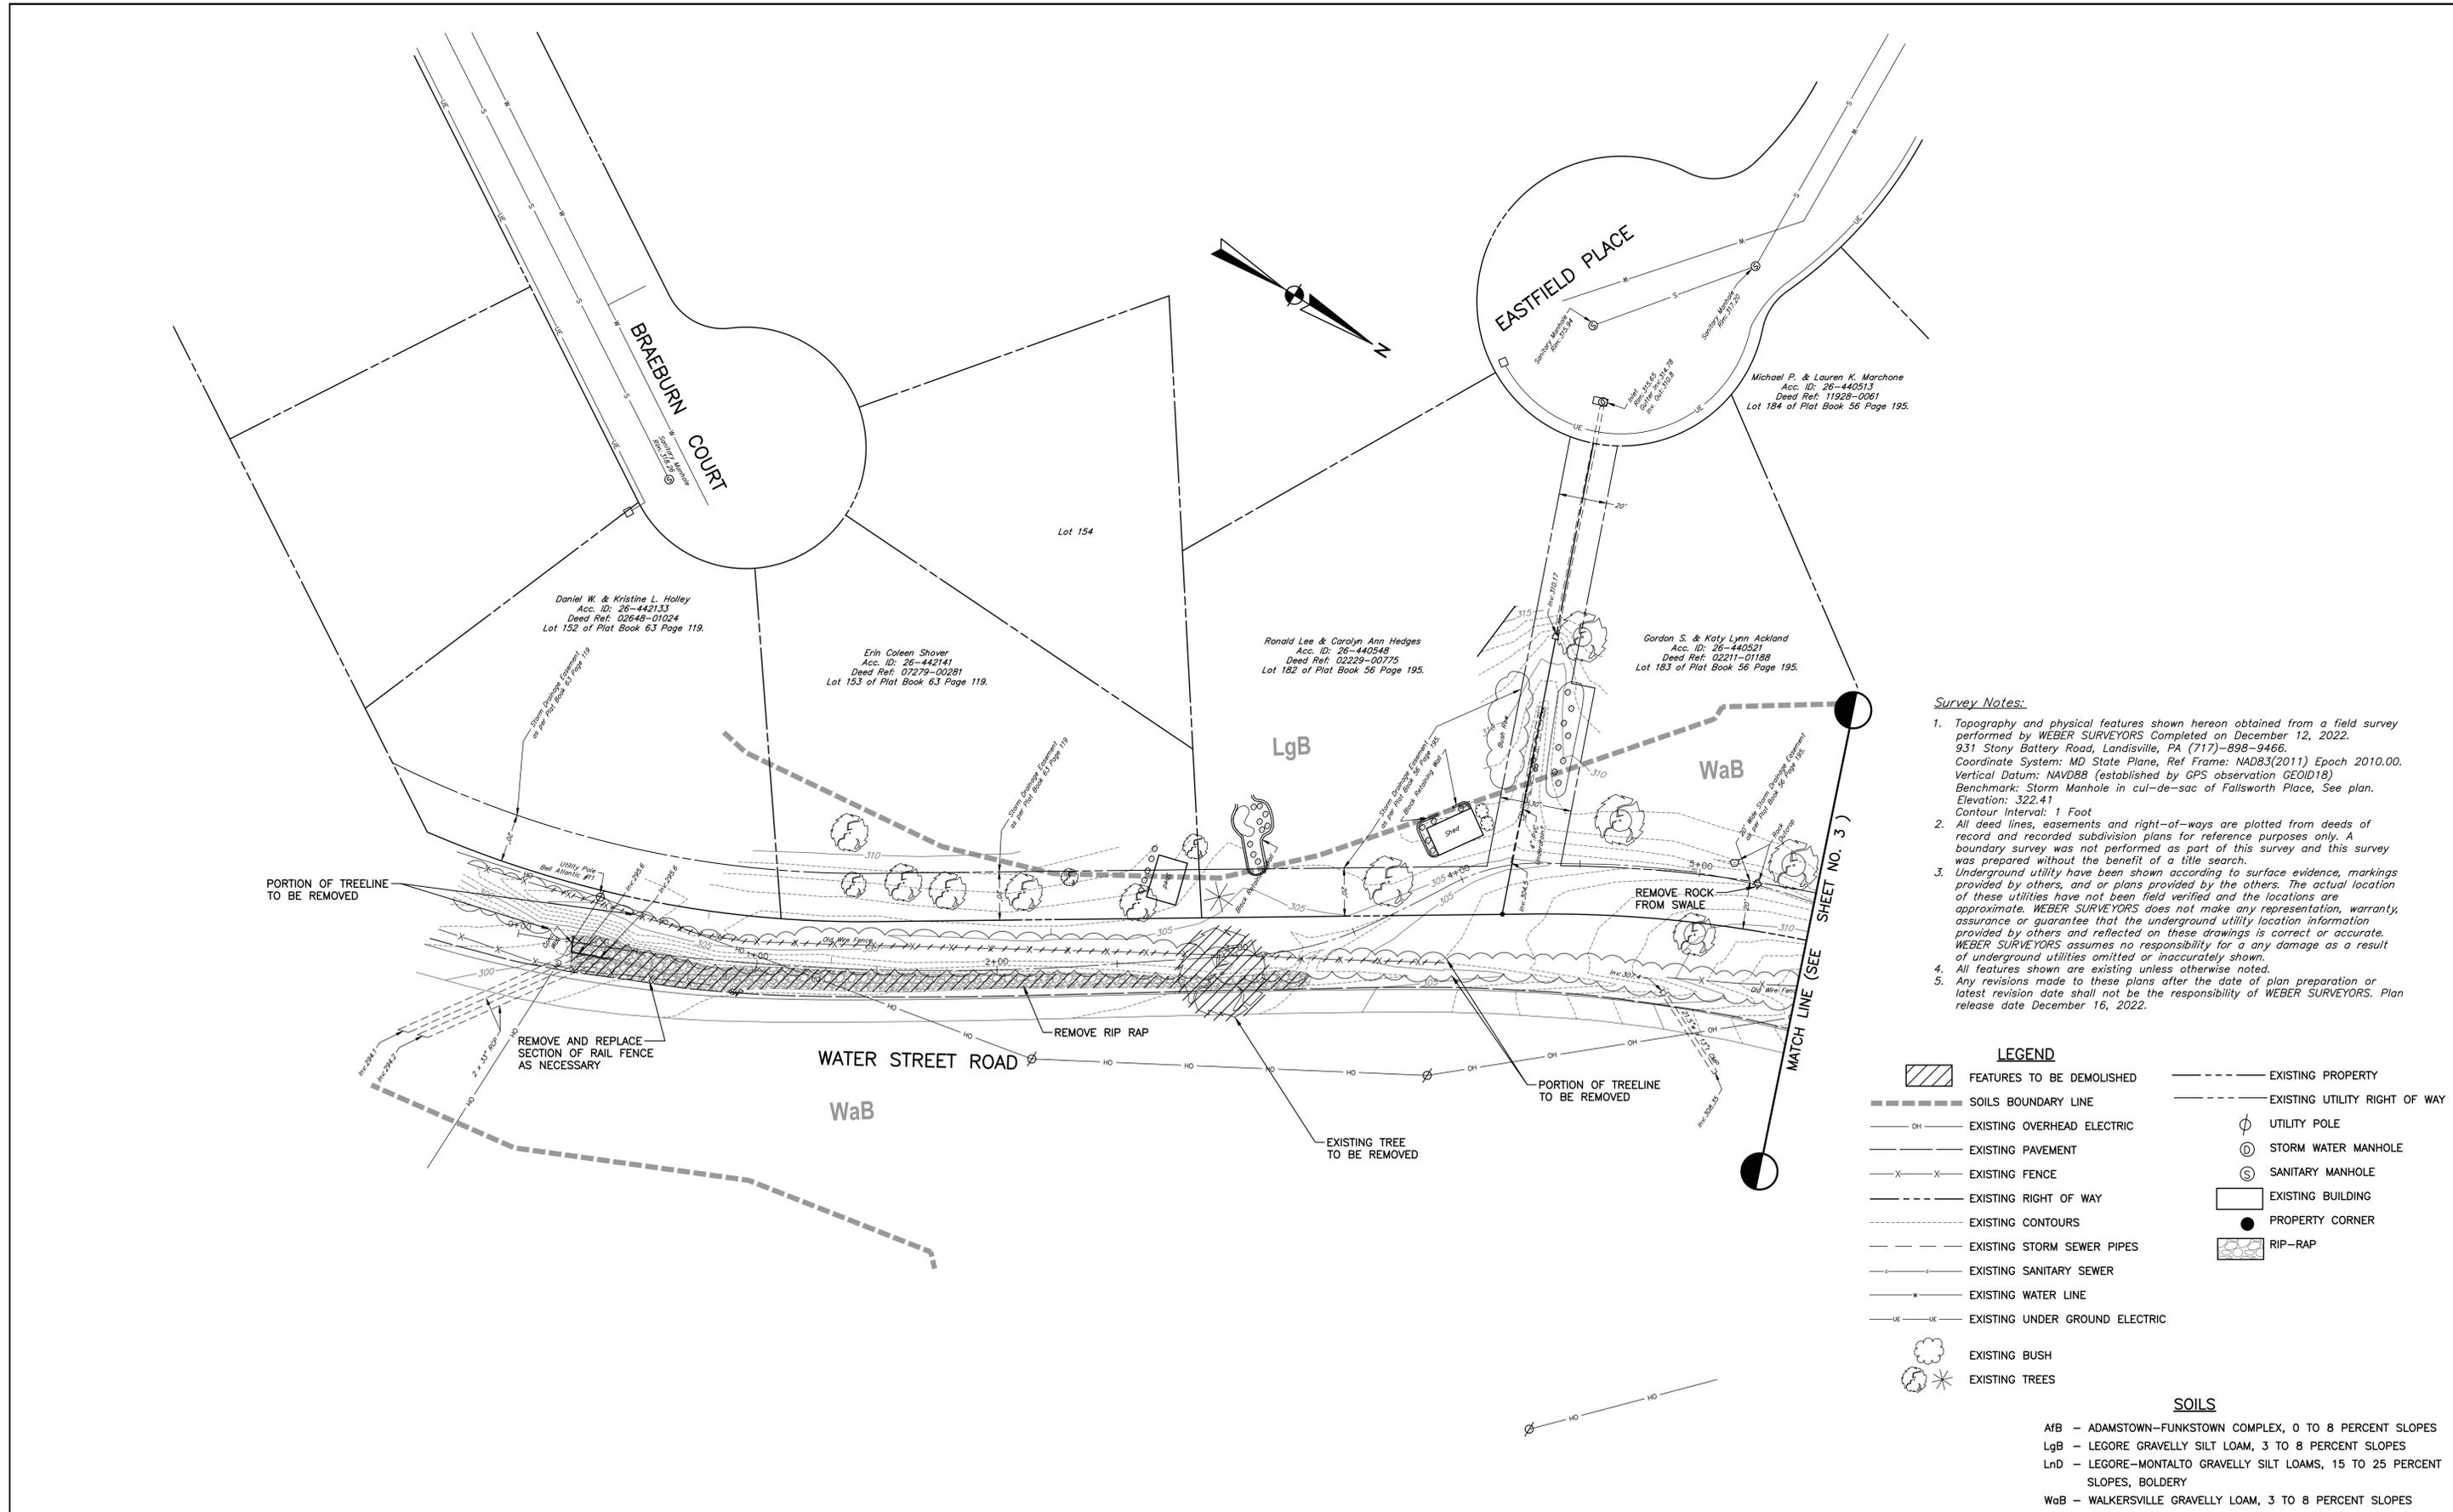

Survey Notes:

- Topography and physical features shown hereon obtained from a field survey performed by WEBER SURVEYORS Completed on December 12, 2022. 931 Stony Battery Road, Landisville, PA (717)-898-9466. Coordinate System: MD State Plane, Ref Frame: NAD83(2011) Epoch 2010.00. Vertical Datum: NAVD88 (established by GPS observation GEOID18). Benchmark: Storm Manhole in cul-de-sac of Fallsworth Place, See plan. Elevation: 322.41. Contour Interval: 1 Foot.
- All deed lines, easements and right-of-ways are plotted from deeds of record and recorded subdivision plans for reference purposes only. A boundary survey was not performed as part of this survey and this survey was prepared without the benefit of a title search.
- Underground utility have been shown according to surface evidence, markings provided by others, and or plans provided by the others. The actual location of these utilities have not been field verified and the locations are approximate. WEBER SURVEYORS does not make any representation, warranty, assurance or guarantee that the underground utility location information provided by others and reflected on these drawings is correct or accurate. WEBER SURVEYORS assumes no responsibility for any damage as a result of underground utilities omitted or inaccurately shown.
- All features shown are existing unless otherwise noted.
- Any revisions made to these plans after the date of plan preparation or latest revision date shall not be the responsibility of WEBER SURVEYORS. Plan release date December 16, 2022.

LEGEND

	FEATURES TO BE DEMOLISHED		EXISTING PROPERTY
	SOILS BOUNDARY LINE		EXISTING UTILITY RIGHT OF WAY
	EXISTING OVERHEAD ELECTRIC		UTILITY POLE
	EXISTING PAVEMENT		STORM WATER MANHOLE
	EXISTING FENCE		SANITARY MANHOLE
	EXISTING RIGHT OF WAY		EXISTING BUILDING
	EXISTING CONTOURS		PROPERTY CORNER
	EXISTING STORM SEWER PIPES		RIP-RAP
	EXISTING SANITARY SEWER		
	EXISTING WATER LINE		
	EXISTING UNDER GROUND ELECTRIC		
	EXISTING BUSH		
	EXISTING TREES		

SOILS

AFB - ADAMSTOWN-FUNKSTOWN COMPLEX, 0 TO 8 PERCENT SLOPES
LgB - LEGORE GRAVELLY SILT LOAM, 3 TO 8 PERCENT SLOPES
Lnd - LEGORE-MONTALTO GRAVELLY SILT LOAMS, 15 TO 25 PERCENT SLOPES, BOLDERY
WaB - WALKERSVILLE GRAVELLY LOAM, 3 TO 8 PERCENT SLOPES

NO	REVISION	DATE	BY	APP.	NO	REVISION	DATE	BY	APP.

EDWARD J. VAN ARSDALE, PE	SEAL
RELEASED BY	
DESIGN	CHECKED
BCU	
DRAWN	CHECKED
CADD	
DATE	JANUARY 2024
SURVEY DATE	DECEMBER 2022
FIELD BOOK	WEBER SURVEYORS




SEAL
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I, EDWARD JOSEPH VAN ARSDALE,
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License No. 38561
Expiration Date: 3/31/2024

CLIENT & PROJECT
TOWN OF WALKERSVILLE
21 WEST FREDERICK STREET
WALKERSVILLE, MARYLAND 21793
BMP DESIGNS
WALKERSVILLE, FREDERICK COUNTY, MARYLAND

ARRG
201 Thomas Johnson Drive Suite 207
Frederick, MD 21702
Tel 301.791.1100

TITLE	DEERFIELD BMP RETROFIT EXISTING CONDITIONS STA 0+00 TO STA 5+50		
SCALE	0 15' 30' 60' 90'	DWG. NO.	S-2
PROJECT NO.	10827.37	SHEET NO.	2 OF 9
REV.			

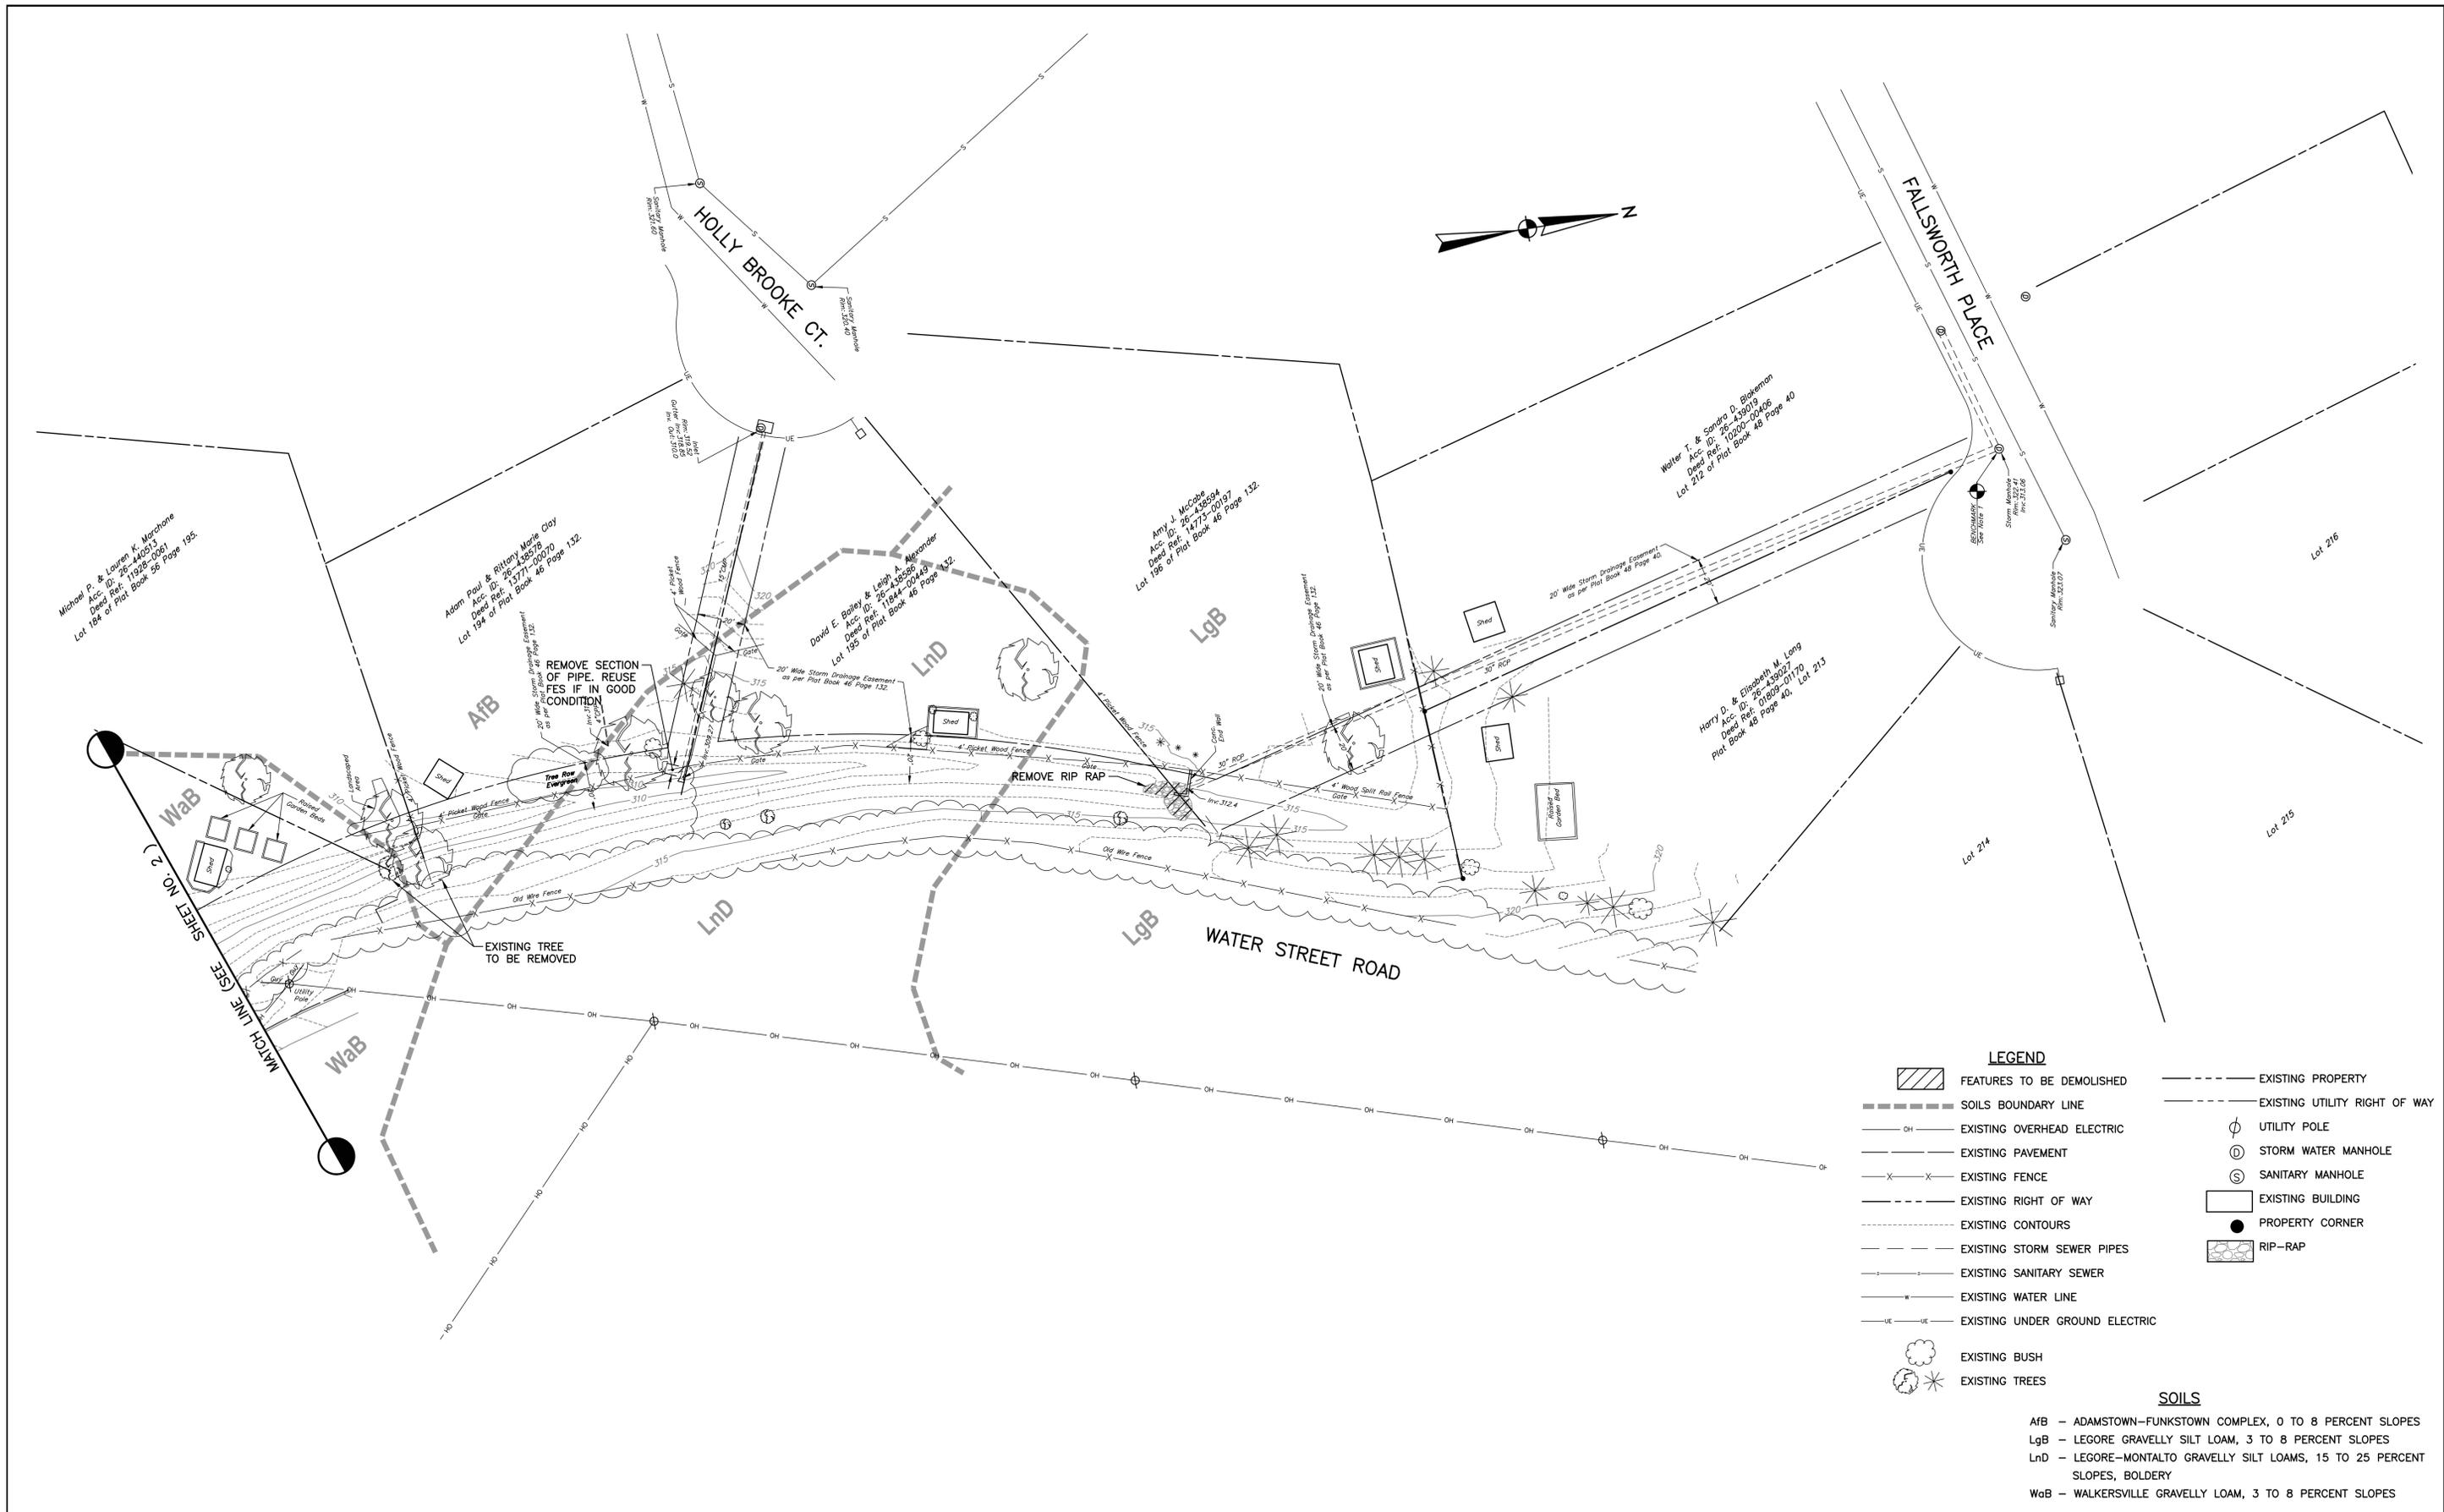

- LEGEND**
- FEATURES TO BE DEMOLISHED
 - SOILS BOUNDARY LINE
 - EXISTING OVERHEAD ELECTRIC
 - EXISTING PAVEMENT
 - EXISTING FENCE
 - EXISTING RIGHT OF WAY
 - EXISTING CONTOURS
 - EXISTING STORM SEWER PIPES
 - EXISTING SANITARY SEWER
 - EXISTING WATER LINE
 - EXISTING UNDER GROUND ELECTRIC
 - EXISTING BUSH
 - EXISTING TREES
 - EXISTING PROPERTY
 - EXISTING UTILITY RIGHT OF WAY
 - UTILITY POLE
 - STORM WATER MANHOLE
 - SANITARY MANHOLE
 - EXISTING BUILDING
 - PROPERTY CORNER
 - RIP-RAP
- SOILS**
- AFB - ADAMSTOWN-FUNKSTOWN COMPLEX, 0 TO 8 PERCENT SLOPES
 - LgB - LEGORE GRAVELLY SILT LOAM, 3 TO 8 PERCENT SLOPES
 - Lnd - LEGORE-MONTALTO GRAVELLY SILT LOAMS, 15 TO 25 PERCENT SLOPES, BOLDERY
 - WaB - WALKERSVILLE GRAVELLY LOAM, 3 TO 8 PERCENT SLOPES

NO	REVISION	DATE	BY	APP.


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 BMP DESIGNS
 WALKERSVILLE, FREDERICK COUNTY, MARYLAND


ARRG
 201 Thomas Johnson Drive Suite 207
 Frederick, MD 21702
 Tel 301.791.1100

TITLE		DEERFIELD BMP RETROFIT EXISTING CONDITIONS STA 5+50 TO STA 9+72	
SCALE	0 15' 30' 60' 90'	DWG. NO.	S-3
PROJECT NO.	10827.37	SHEET NO.	3 OF 9
REV.			



PLAN AND PROFILE
SCALE: HORIZ 1" = 30' VERT 1" = 5'

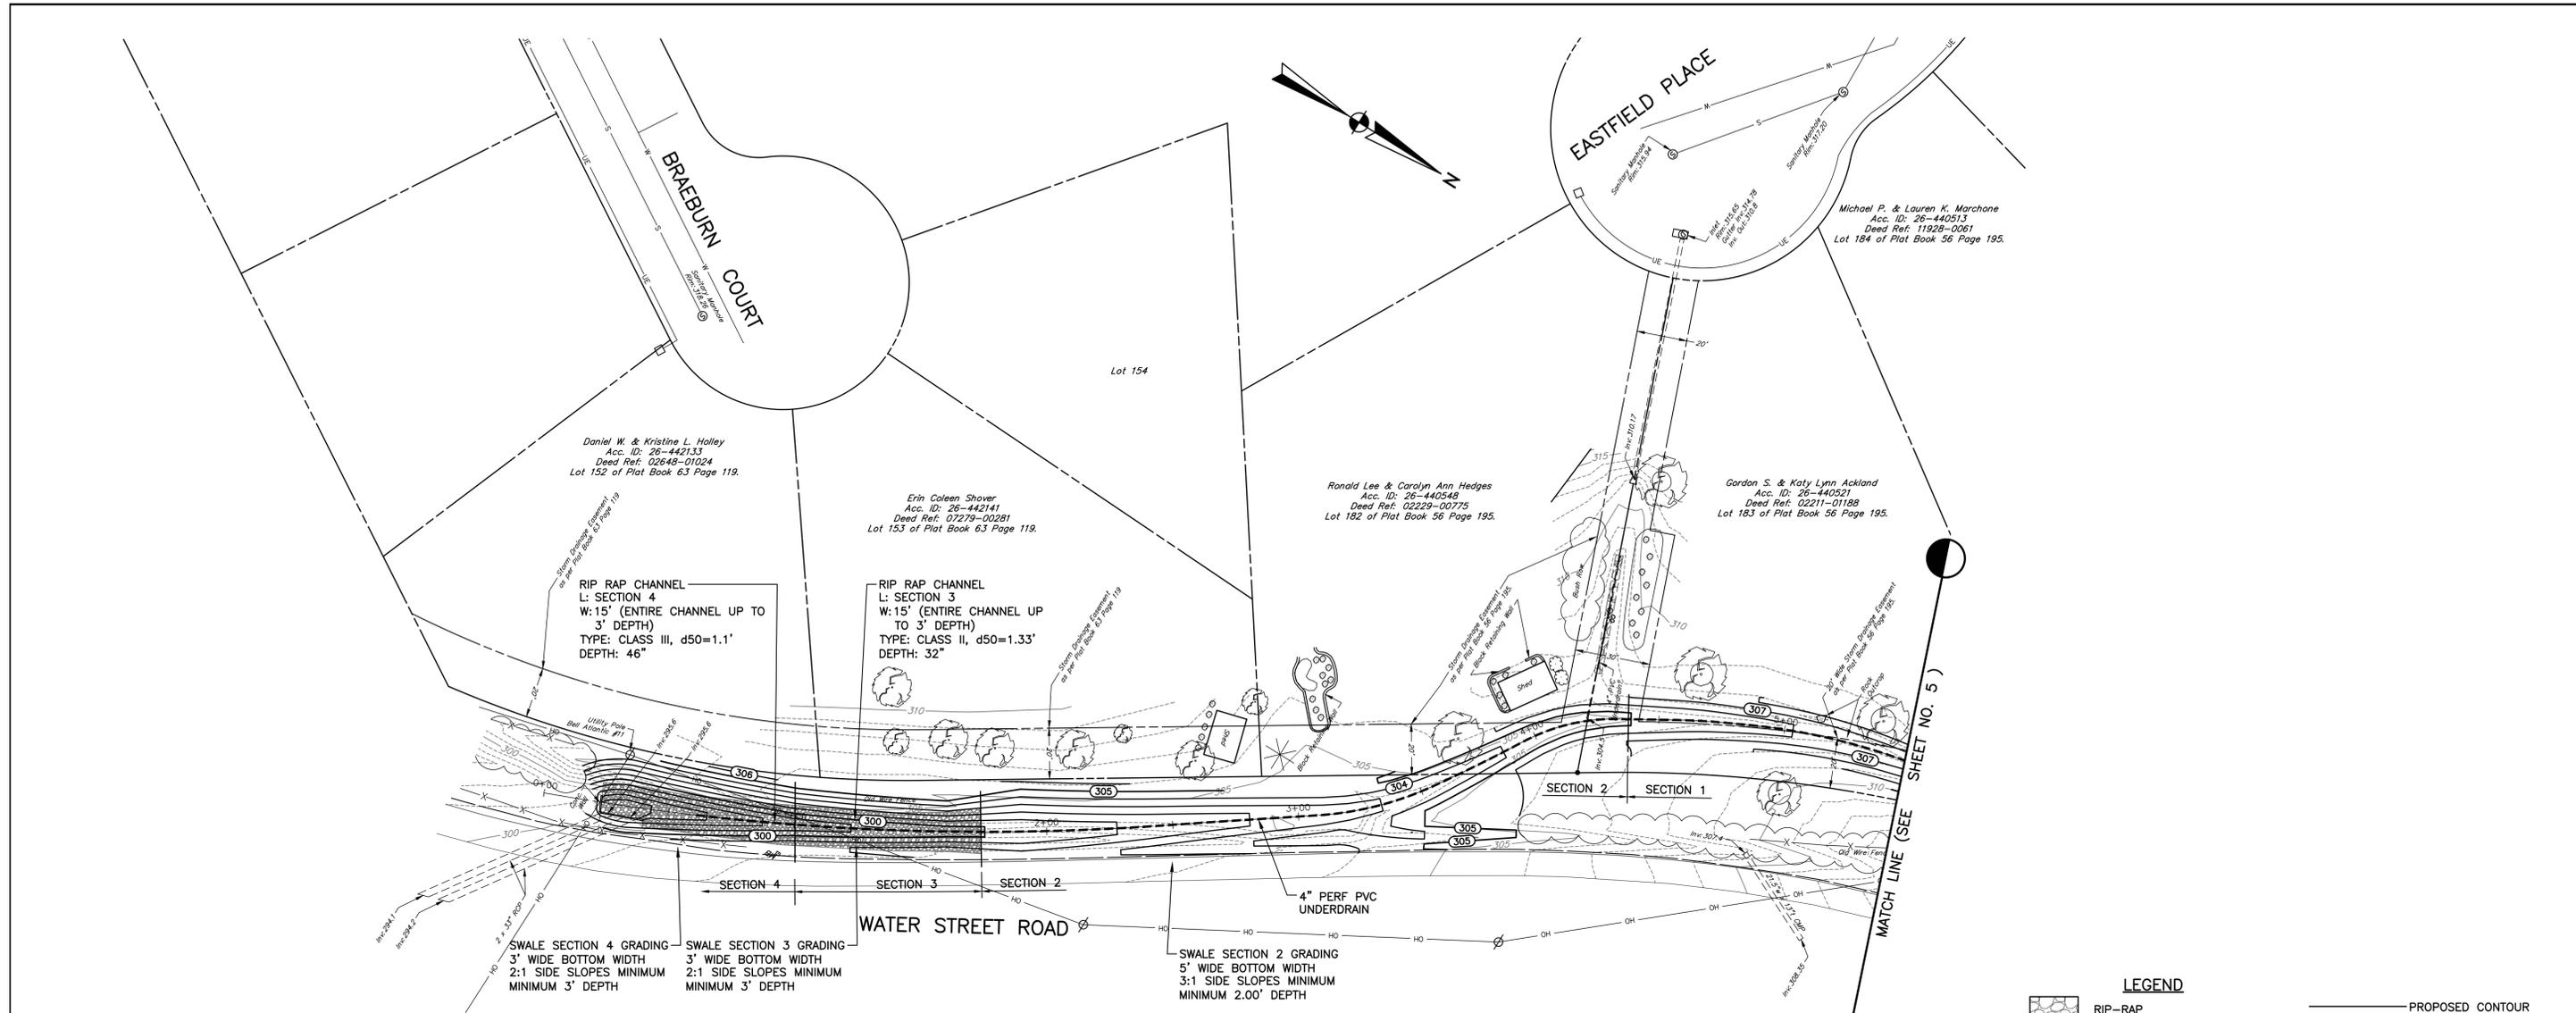- LEGEND**
- RIP-RAP
 - PROPOSED STORM
 - EXISTING OVERHEAD ELECTRIC
 - EXISTING PAVEMENT
 - EXISTING FENCE
 - EXISTING RIGHT OF WAY
 - EXISTING CONTOURS
 - EXISTING STORM SEWER PIPES
 - EXISTING SANITARY SEWER
 - EXISTING WATER LINE
 - EXISTING UNDER GROUND ELECTRIC
 - EXISTING BUSH
 - EXISTING TREES
 - PROPOSED CONTOUR
 - EXISTING PROPERTY
 - EXISTING UTILITY RIGHT OF WAY
 - UTILITY POLE
 - STORM WATER MANHOLE
 - SANITARY MANHOLE
 - EXISTING BUILDING
 - PROPERTY CORNER

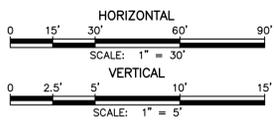

DATUM ELEV
292.00

FREDERICK SOIL CONSERVATION DISTRICT
Erosion And Sediment Control Plan Approval

By: _____
District Manager or Designee

Date: _____

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DRAWN	CHECKED	SURVEY DATE DECEMBER 2022 FIELD BOOK WEBER SURVEYORS
CADD		
DATE	JANUARY 2024	1/4/24


CLIENT & PROJECT

TOWN OF WALKERSVILLE
21 WEST FREDERICK STREET
WALKERSVILLE, MARYLAND 21793

BMP DESIGNS
WALKERSVILLE, FREDERICK COUNTY, MARYLAND



TITLE		DEERFIELD BMP RETROFIT PROPOSED CONDITIONS STA 0+00 TO STA 5+50	
SCALE	AS SHOWN	DWG. NO.	S-4
PROJECT NO.	10827.37	SHEET NO.	4 OF 9
REV.			

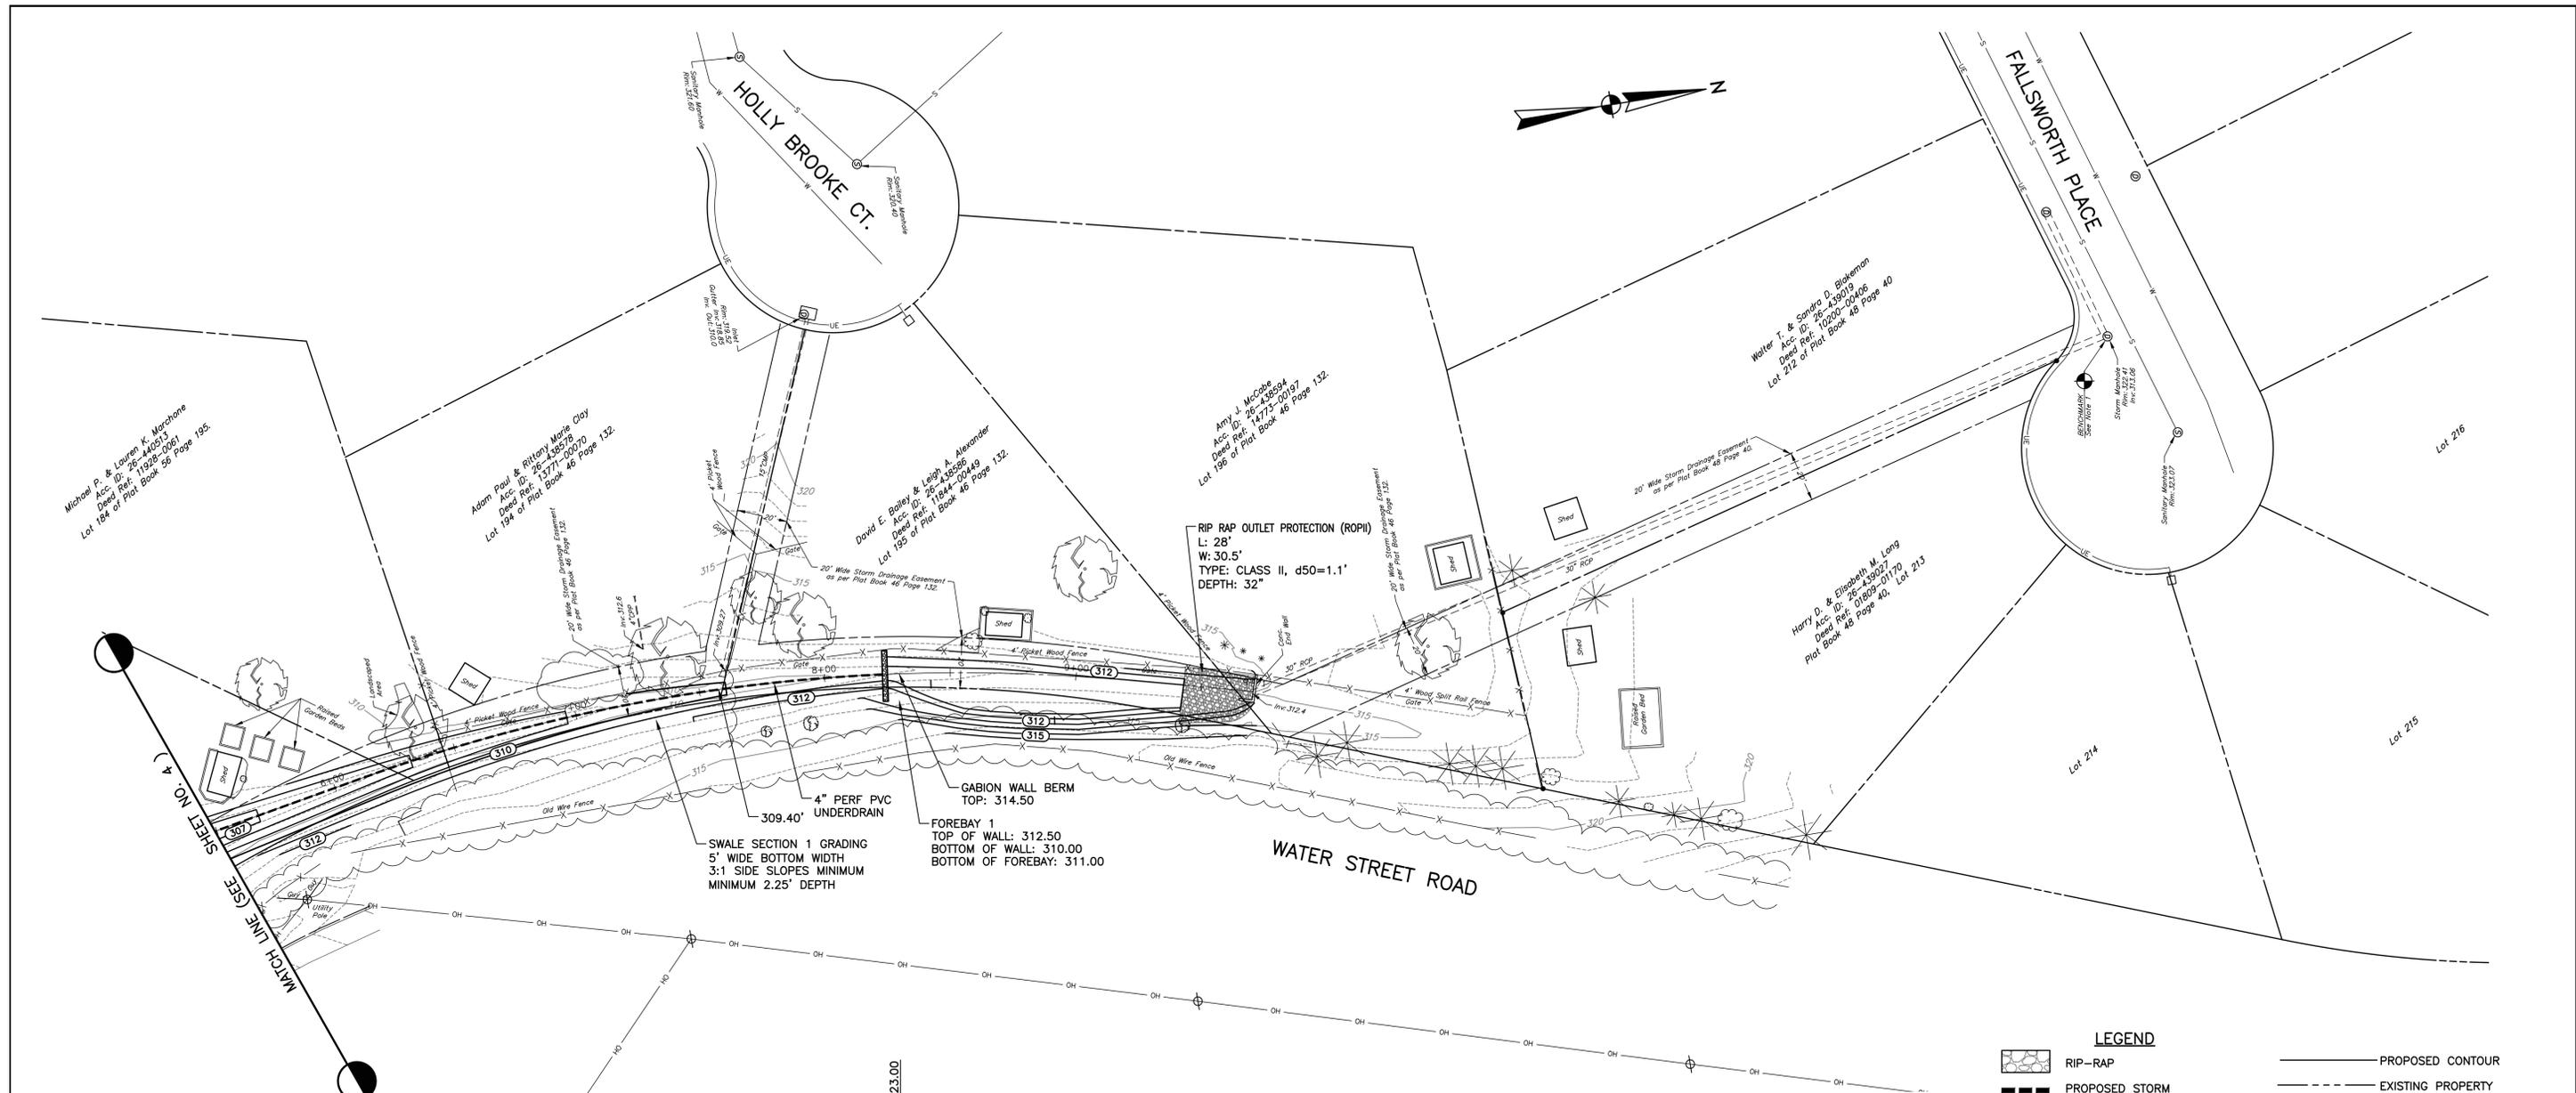


RIP RAP OUTLET PROTECTION (ROPII)
 L: 28'
 W: 30.5'
 TYPE: CLASS II, d50=1.1'
 DEPTH: 32"


FOREBAY 1
 TOP OF WALL: 312.50
 BOTTOM OF WALL: 310.00
 BOTTOM OF FOREBAY: 311.00

SWALE SECTION 1 GRADING
 5' WIDE BOTTOM WIDTH
 3:1 SIDE SLOPES MINIMUM
 MINIMUM 2.25' DEPTH

MATCH LINE (SEE SHEET NO. 4)

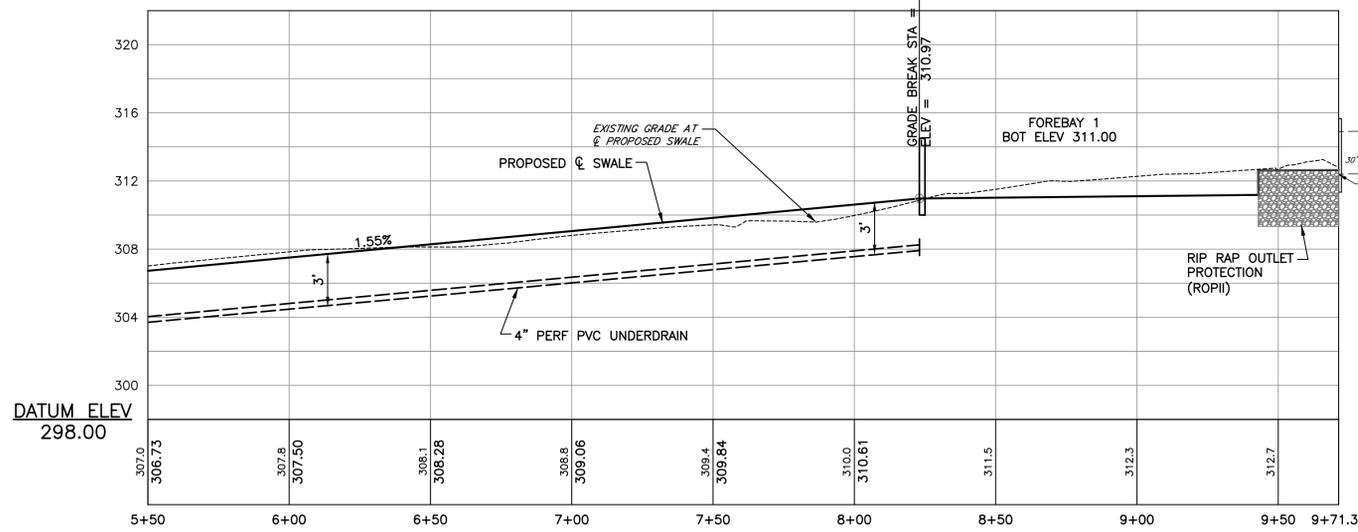

LEGEND	
	RIP-RAP
	PROPOSED STORM
	EXISTING OVERHEAD ELECTRIC
	EXISTING PAVEMENT
	EXISTING FENCE
	EXISTING RIGHT OF WAY
	EXISTING CONTOURS
	EXISTING STORM SEWER PIPES
	EXISTING SANITARY SEWER
	EXISTING WATER LINE
	EXISTING UNDER GROUND ELECTRIC
	EXISTING BUSH
	EXISTING TREES
	PROPOSED CONTOUR
	EXISTING PROPERTY
	EXISTING UTILITY RIGHT OF WAY
	UTILITY POLE
	STORM WATER MANHOLE
	SANITARY MANHOLE
	EXISTING BUILDING
	PROPERTY CORNER

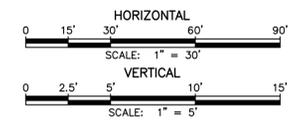

FREDERICK SOIL CONSERVATION DISTRICT
 Erosion And Sediment Control Plan Approval

By: _____
 District Manager or Designee

Date: _____
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BCU	
DRAWN	CHECKED
CADD	
DATE	JANUARY 2024
SURVEY DATE	DECEMBER 2022
FIELD BOOK	WEBER SURVEYORS
	1/4/24

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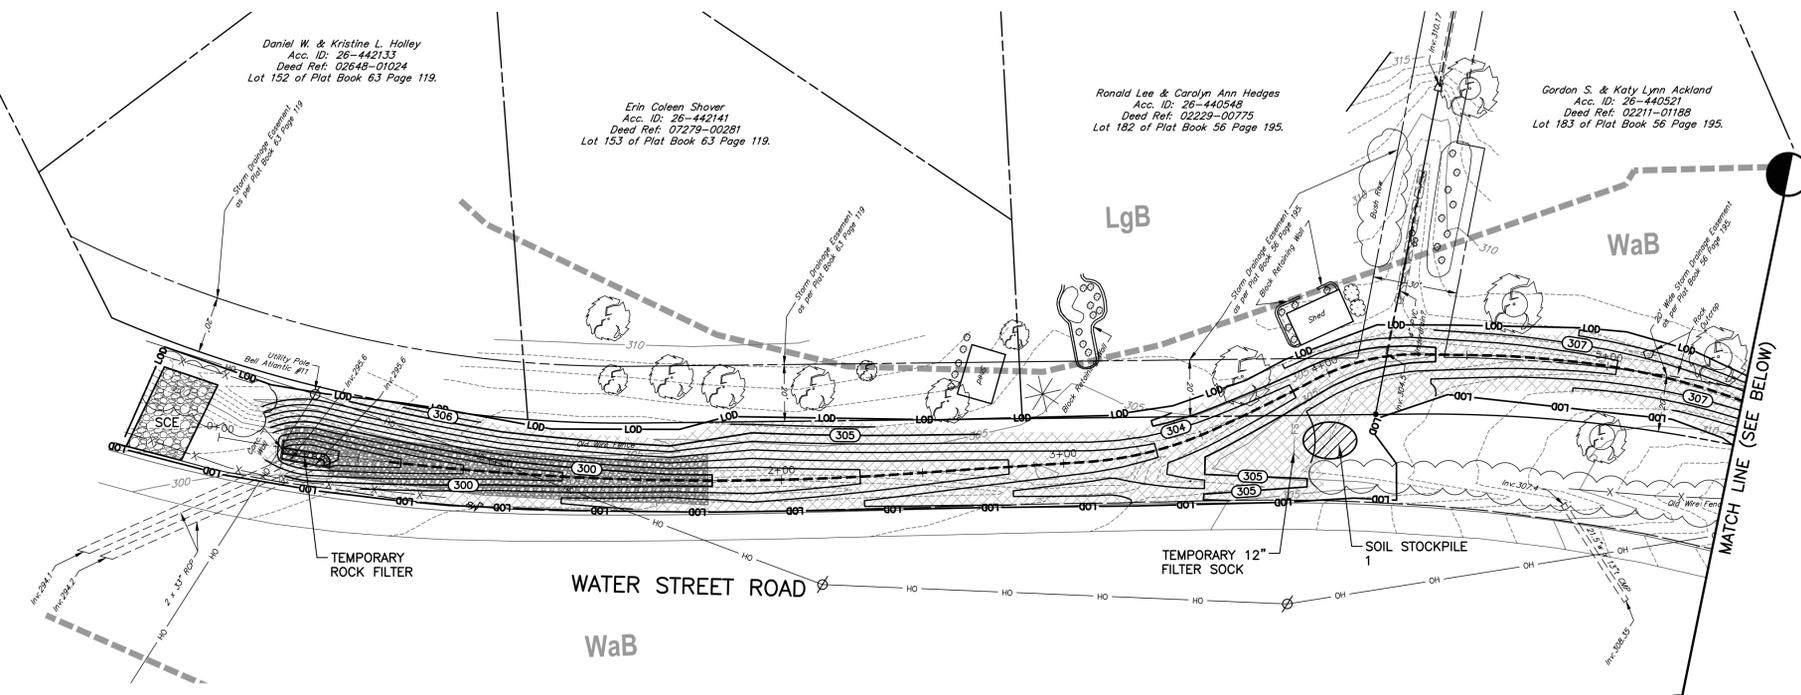
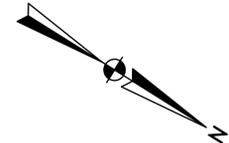
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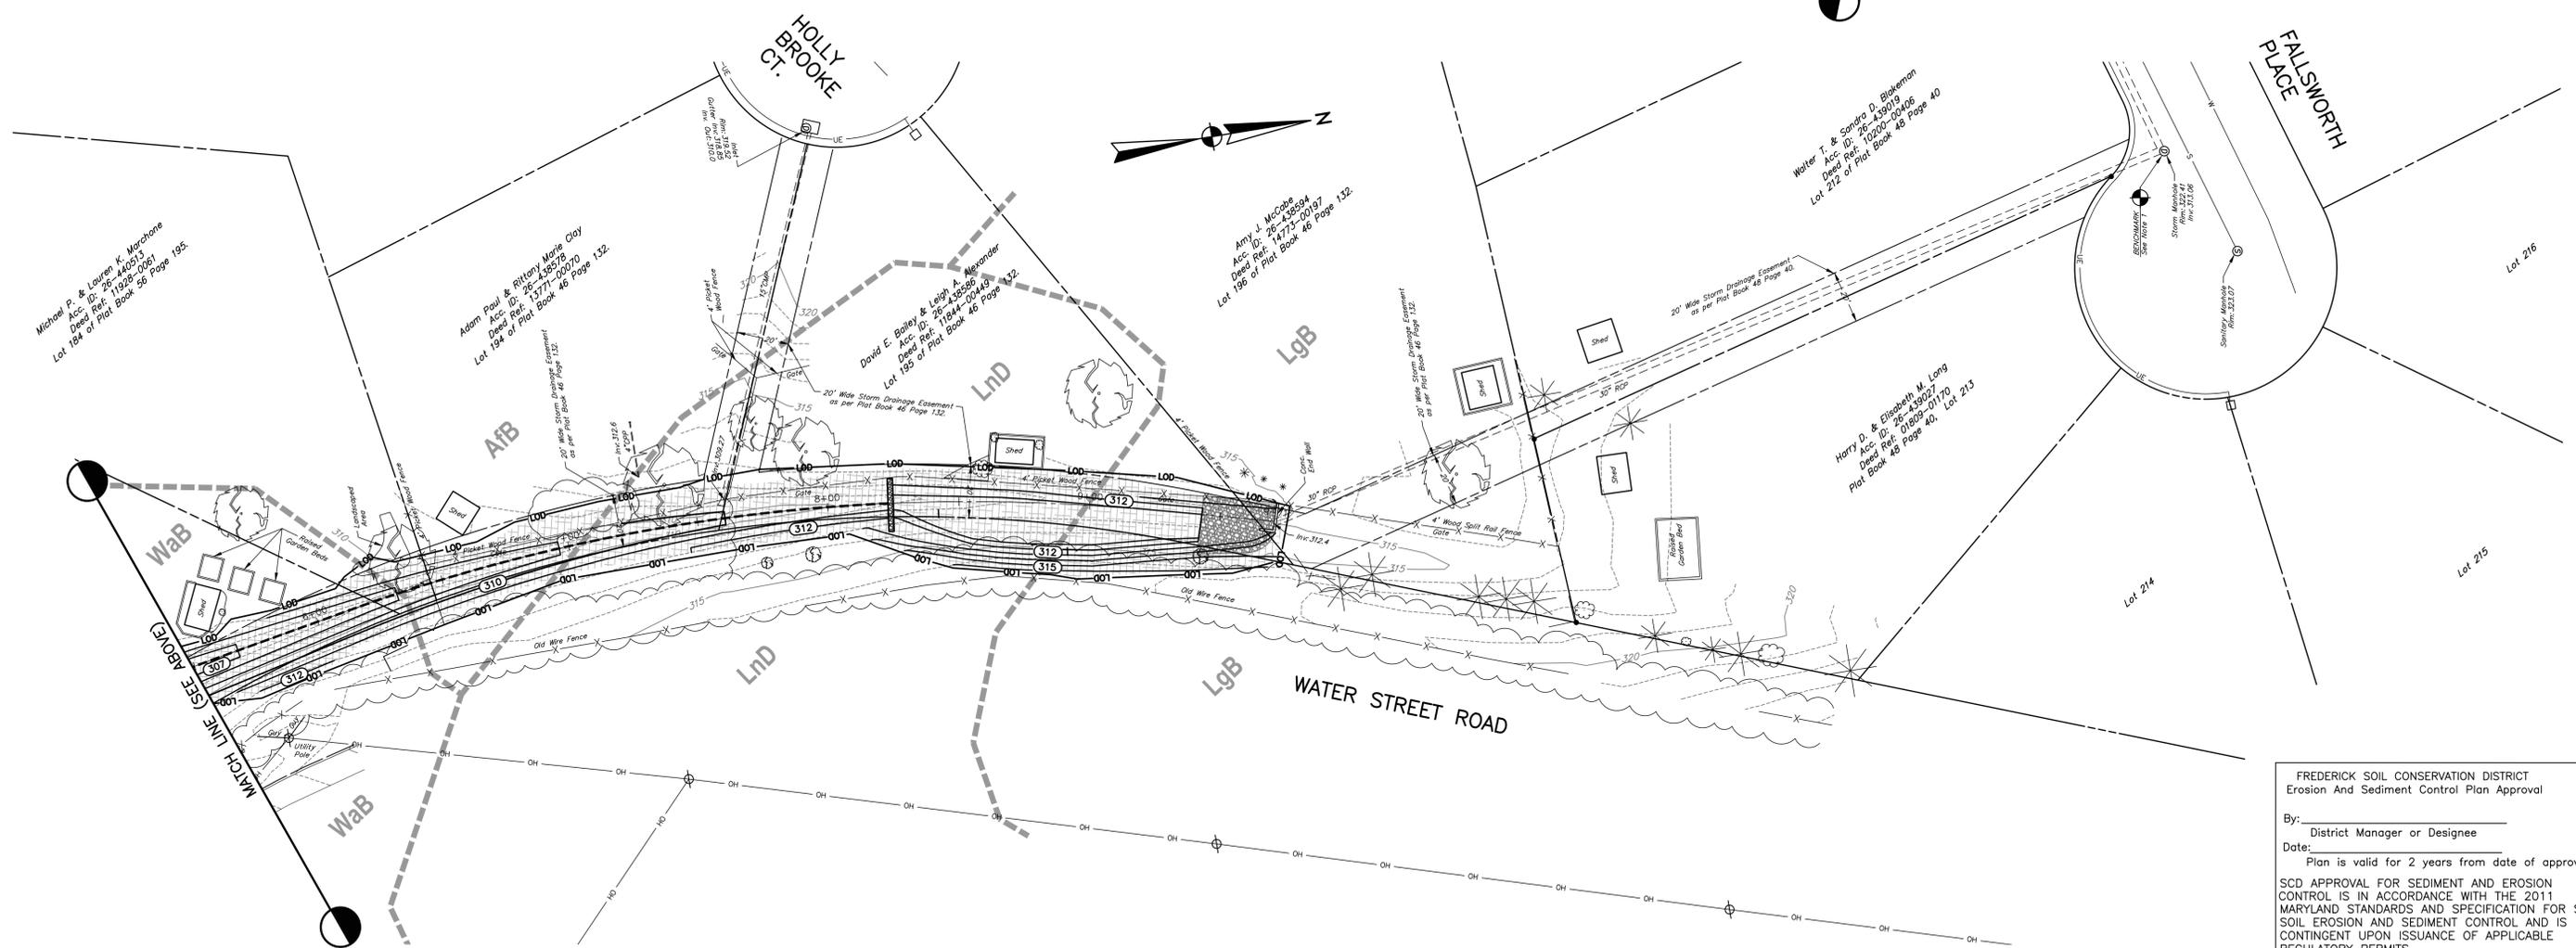
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TITLE	DEERFIELD BMP RETROFIT PROPOSED CONDITIONS STA 5+50 TO STA 9+72		
SCALE	AS SHOWN		
PROJECT NO.	10827.37	SHEET NO.	5 OF 9
DWG. NO.	S-5		



- LEGEND**
- SOIL BOUNDARY LINE
 - TSSMS [Pattern] TEMPORARY SOIL STABILIZATION MATTING SLOPE APPLICATION 2.25 PSF SHEAR STRESS (NAG C125) (DETAIL B-4-6-B)
 - FL — FL — 12" FILTER LOG (DETAIL E-6)
 - L00 — L00 — LIMIT OF DISTURBANCE (34,207.83 SF, 0.79 AC)
 - FS — FS — TEMPORARY 12" FILTER SOCK
 - SCE [Pattern] STABILIZED CONSTRUCTION ENTRANCE (DETAIL B-1)
 - [Pattern] MATERIAL STOCKPILE
 - [Pattern] TEMPORARY ROCK FILTER
- SOILS**
- AFB - ADAMSTOWN-FUNKSTOWN COMPLEX, 0 TO 8 PERCENT SLOPES
 - LgB - LEGORE GRAVELLY SILT LOAM, 3 TO 8 PERCENT SLOPES
 - LnD - LEGORE-MONTALTO GRAVELLY SILT LOAMS, 15 TO 25 PERCENT SLOPES, BOLDERY
 - WaB - WALKERSVILLE GRAVELLY LOAM, 3 TO 8 PERCENT SLOPES



FREDERICK SOIL CONSERVATION DISTRICT
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District Manager or Designee

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EDWARD J. VAN ARSDALE, PE	
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BCU	
DRAWN	CHECKED
CADD	
DATE	SURVEY DATE
JANAUARY 2024	DECEMBER 2022
	FIELD BOOK
	WEBER SURVEYORS




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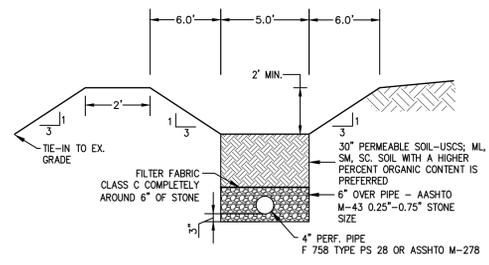
CLIENT & PROJECT
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BMP DESIGNS
WALKERSVILLE, FREDERICK COUNTY, MARYLAND




TITLE DEERFIELD BMP RETORFIT EROSION AND SEDIMENT CONTROL PLAN	
SCALE 0 15' 30' 60' 90'	DWG. NO. S-6
PROJECT NO. 10827.37	SHEET NO. 6 OF 9
	REV.

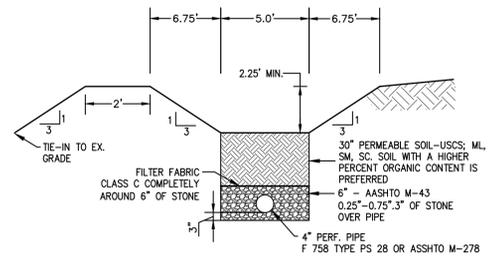

SECTION 1



SECTION 2

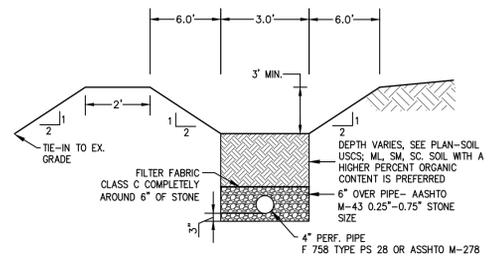


SECTION 3/4

SWALE SECTIONS

NO SCALE


STORMWATER MANAGEMENT FACILITY SUMMARY TABLE												
SWM BMP	SITE AREA (AC.)	LOD (AC.)	DRAINAGE AREA (AC.)	IMPERVIOUS AREA (AC.)	% IMPERVIOUS	PE PROVIDED (IN)	ESDV/WQV REQUIRED (ACRE*FT)	ESDV/WQV PROVIDED (ACRE*FT)	SURFACE AREA PROVIDED (SF)	RCN	TC(MIN)	IMPERVIOUS CREDITS (ACRES)
DEERFIELD SWALE	0.7385	0.7385	36.06	6.92	19.18	1.00	0.1554	0.1556	11,078	71	21.7	6.92

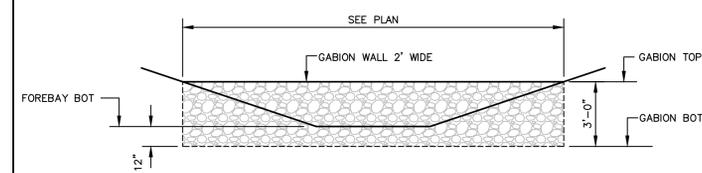

FOREBAY NO.	FOREBAY BOTTOM ELEV	GABION TOP WALL ELEV	GABION BOT WALL ELEV	WALL LENGTH (FT.)	WALL HEIGHT (FT.)	WALL WIDTH (FT.)
1	311.00	312.50	310.00	AS SHOWN	2.5	2

GABION FOREBAY DETAIL

NO SCALE

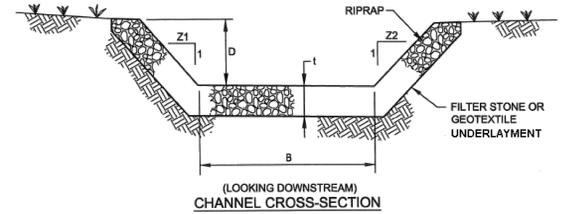

Section	Stations	B	D	Z1	Z2	Riprap Gradation	t	Underlayment	Underlayment Thickness
3	N/A	3'	3'	2:1	2:1	CLASS II	32"	NONWOVEN GEOTEXTILE FABRIC	N/A
4	N/A	3'	3'	2:1	2:1	CLASS III	48"	NONWOVEN GEOTEXTILE FABRIC	N/A

RIPRAP CHANNEL DETAIL

NO SCALE

NO	REVISION	DATE	BY	APP.	NO	REVISION	DATE	BY	APP.

DESIGNED BY EDWARD J. VAN ARSDALE, PE	CHECKED
DRAWN CADD	CHECKED
DATE JANUARY 2023	SURVEY DATE DECEMBER 2022
	FIELD BOOK WEBER SURVEYORS








SEAL
PROFESSIONAL CERTIFICATION
I, EDWARD JOSEPH VAN ARSDALE,
III, P.E. hereby certify that these
documents were prepared or approved
by me, and that I am a duly licensed
professional engineer under the laws
of the State of Maryland,
License No. 38561
Expiration Date: 3/31/2024

CLIENT & PROJECT
TOWN OF WALKERSVILLE
21 WEST FREDERICK STREET
WALKERSVILLE, MARYLAND 21793

BMP DESIGNS
WALKERSVILLE, FREDERICK COUNTY, MARYLAND




TITLE DEERFIELD BMP RETROFIT DESIGN DETAILS		DWG. NO. S-7
SCALE AS SHOWN	SHEET NO. 7 OF 9	
PROJECT NO. 10827.37	REV.	

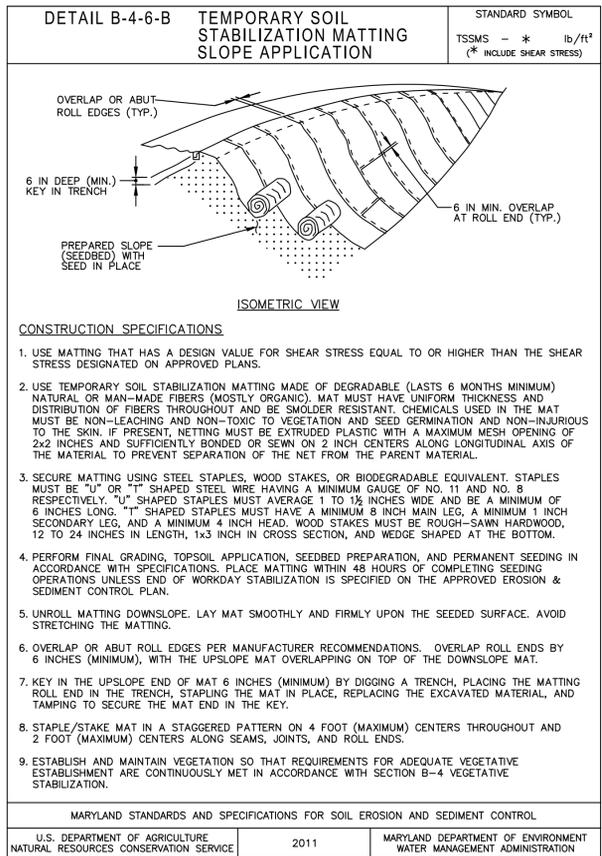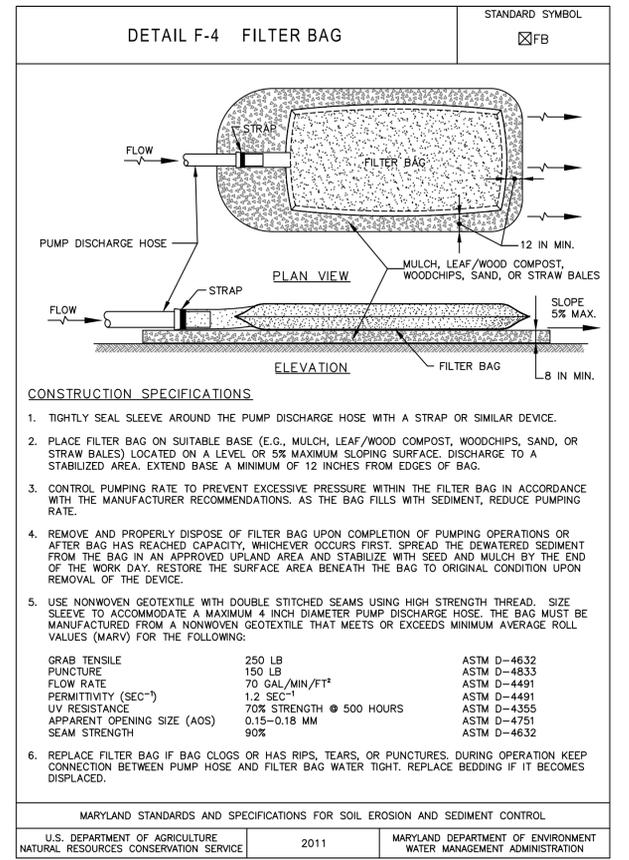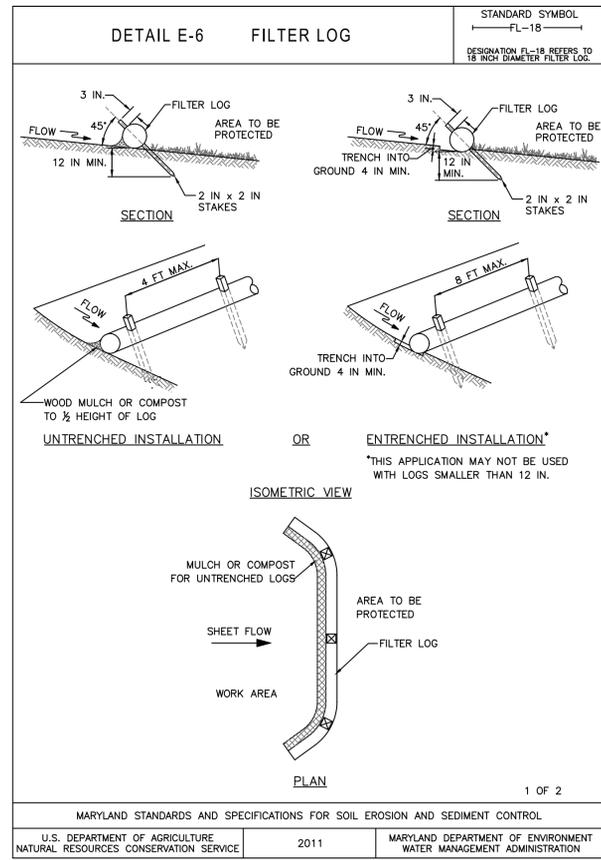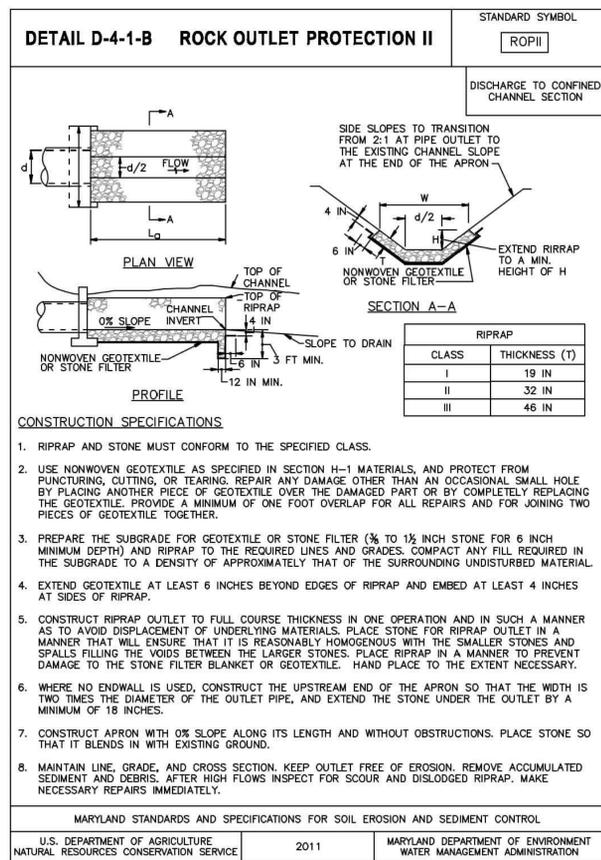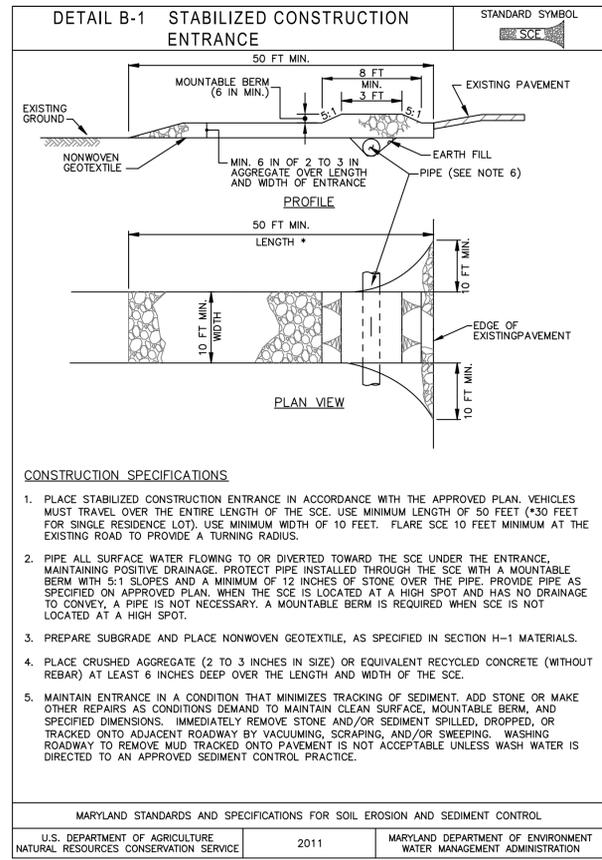

STRUCTURE NAME	APRON LENGTH L (FT)	APRON WIDTH W (FT)	RIP-RAP TYPE R	APRON DEPTH D (IN)	PIPE DIAMETER (IN)
30" RCP (IN)	28	30.5	CLASS II (d ₅₀ =1.1')	32	30

MARYLAND STANDARDS AND SPECIFICATIONS FOR SOIL EROSION AND SEDIMENT CONTROL
 U.S. DEPARTMENT OF AGRICULTURE NATURAL RESOURCES CONSERVATION SERVICE 2011 MARYLAND DEPARTMENT OF ENVIRONMENT WATER MANAGEMENT ADMINISTRATION

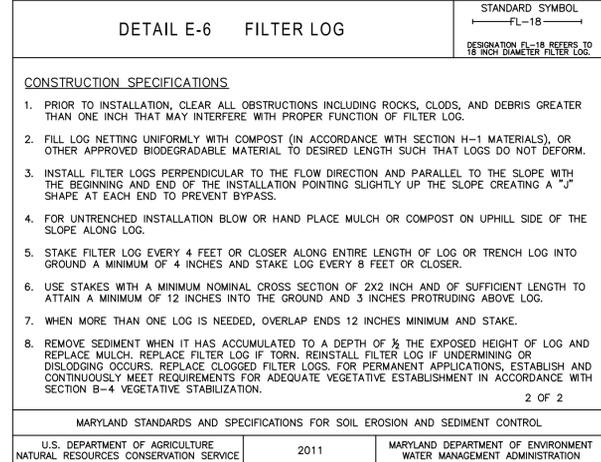

FREDERICK SOIL CONSERVATION DISTRICT
 Erosion And Sediment Control Plan Approval

By: _____
 District Manager or Designee

Date: _____
 Plan is valid for 2 years from date of approval

SCD APPROVAL FOR SEDIMENT AND EROSION CONTROL IS IN ACCORDANCE WITH THE 2011 MARYLAND STANDARDS AND SPECIFICATION FOR SOIL EROSION AND SEDIMENT CONTROL AND IS CONTINGENT UPON ISSUANCE OF APPLICABLE REGULATORY PERMITS.

NO	REVISION	DATE	BY	APP.	NO	REVISION	DATE	BY	APP.
EDWARD J. VAN ARSDALE, PE DESIGN BY					SEAL				
BCU					STATE OF MARYLAND PROFESSIONAL ENGINEER				
DRAWN					I, EDWARD JOSEPH VAN ARSDALE, III, P.E., hereby certify that these documents were prepared or approved by me, and that I am a duly licensed professional engineer under the laws of the State of Maryland, License No. 38561, Expiration Date: 3/31/2024				
CADD					CLIENT & PROJECT				
DATE					TOWN OF WALKERSVILLE 21 WEST FREDERICK STREET WALKERSVILLE, MARYLAND 21793				
JANUARY 2023					BMP DESIGNS WALKERSVILLE, FREDERICK COUNTY, MARYLAND				
SURVEY DATE					201 Thomas Johnson Drive Suite 207 Frederick, MD 21702 Tel 301.791.1100				
DECEMBER 2022					TITLE				
FIELD BOOK					DEERFIELD BMP RETROFIT EROSION AND SEDIMENT CONTROL DETAILS				
WEBER SURVEYORS					SCALE				
1/4/24					AS SHOWN				
					DWG. NO.				
					S-8				
					PROJECT NO.				
					1082737				
					SHEET NO.				
					8 OF 9				
					REV.				

SEDIMENT CONTROL NOTES

- ALL EROSION AND SEDIMENT CONTROL STRUCTURES SHALL BE INSTALLED PRIOR TO GRADING OPERATIONS.
- ALL EROSION AND SEDIMENT CONTROL STRUCTURES SHALL BE MAINTAINED IN GOOD WORKING ORDER WITH PERIODIC INSPECTIONS AND REPAIR IF NECESSARY. DURING CONSTRUCTION, ALL SEDIMENT CONTROL STRUCTURES WILL BE INSPECTED AFTER EACH RAINFALL AND REPAIRED IF NECESSARY. SEDIMENT TO BE REMOVED TO A SUITABLE DISPOSAL AREA AND STABILIZED WITH PERMANENT VEGETATIVE COVER.
- ANY TEMPORARY STRUCTURES SHALL BE REMOVED WHEN THE DISTURBED AREAS HAVE BEEN PERMANENTLY STABILIZED.
- IF THE COUNTY SEDIMENT CONTROL INSPECTOR FINDS THAT ADDITIONAL SEDIMENT CONTROL MEASURES ARE NECESSARY, HE MAY DIRECT THE CONTRACTOR TO EITHER INSTALL THE ADDITIONAL MEASURES, OR SUBMIT A REVISED GRADING PLAN TO THE FCSD FOR APPROVAL.
- ALL DISTURBED AREAS SHALL BE STABILIZED BY GRASS, GRAVEL, PAVEMENT, CROWN VETCH, OR OTHER APPROVED MEANS AS SOON AS POSSIBLE UPON COMPLETION OF EXCAVATION.
- THE FREDERICK COUNTY SOIL CONSERVATION DISTRICT RESERVES THE RIGHT TO ADD TO, DELETE, OR MODIFY ANY OR ALL SEDIMENT CONTROL MEASURES AS SHOWN HEREON AS NEEDED TO ESTABLISH PROPER SOIL STABILIZATION AND EROSION AND SEDIMENT CONTROL ANYTIME THROUGHOUT THE LIFE OF THE PROJECT.
- REFERENCE IS HEREBY MADE TO THE "STANDARDS AND SPECIFICATIONS FOR EROSION AND SEDIMENT CONTROL IN DEVELOPING AREAS", USDA-USC, 1994 FOR STANDARDS AND REQUIREMENTS.
- ALL EROSION/SEDIMENT CONTROL MEASURES SHALL COMPLY WITH THE "MARYLAND STANDARDS AND SPECIFICATIONS FOR SOIL EROSION AND SEDIMENT CONTROL" AS APPROVED BY THE FREDERICK COUNTY SOIL CONSERVATION DISTRICT.
- FOLLOWING INITIAL SOIL DISTURBANCE OR REDISTURBANCE, PERMANENT OR TEMPORARY STABILIZATION SHALL BE COMPLETED WITHIN:
 - SEVEN (7) CALENDAR DAYS AS TO THE SURFACE OF ALL PERIMETER CONTROLS, DIKES, SWALES, DITCHES, PERIMETER SLOPES, AND ALL SLOPES GREATER THAN 3 HORIZONTAL TO 1 VERTICAL; AND
 - FOURTEEN (14) DAYS AS TO ALL OTHER DISTURBED OR GRADED AREAS ON THE PROJECT SITE.
- APPROVAL FROM THE SEDIMENT CONTROL INSPECTOR IS NEEDED TO REMOVE SEDIMENT CONTROL STRUCTURES.
- ALL SOIL STOCKPILES SHALL BE TEMPORARILY SEEDED AND SILT FENCE PLACED AROUND THE BASE. THE STOCKPILES SHOULD BE PLACED WITHIN THE LIMITS OF THE DISTURBED AREAS.
- ALL UTILITIES, SUCH AS STORM DRAIN, PUBLIC WATER, SANITARY SEWER, ELECTRIC POWER, TELEPHONE, CABLE, AND GAS LINES THAT ARE NOT IN PAVED AREAS ARE NOT UNDERGOING ACTIVE GRADING SHALL BE TEMPORARILY OR PERMANENTLY STABILIZED WITHIN 3 DAYS OF INITIAL DISTURBANCE.

FOR UTILITY WORK ONLY OR FOR OFF-SITE UTILITY WORK

- PLACE ALL EXCAVATED MATERIAL ON THE HIGH SIDE OF THE TRENCH, SILT FENCE ON THE LOW SIDE.
- ONLY DO AS MUCH WORK AS CAN BE DONE IN ONE DAY SO BACKFILLING, FINAL GRADING, SEEDING AND MULCHING CAN OCCUR.
- ANY SEDIMENT CONTROL MEASURES DISTURBED BY CONSTRUCTION SHALL BE REPAIRED ON THE SAME DAY.

STOCKPILE NOTES

- NO STOCKPILING ALLOWED ON ASPHALT.
- ALL STOCKPILES LEFT AT THE END OF THE DAY NEED TO BE STABILIZED UNTIL THE NEXT REDISTURBANCE.

VEGETATIVE SPECIFICATIONS AND NOTES

- DISTURB AS SMALL OF THE PRESENT COVER AS POSSIBLE WHILE PERFORMING GRADING.
- ESTABLISH PERMANENT VEGETATIVE COVER IMMEDIATELY AFTER FINAL GRADING IS COMPLETED. (THIS INCLUDES ALL GRADING ON OR OFF THE SITE THAT IS AFFECTED BY THIS CONSTRUCTION). IF FINAL GRADING IS COMPLETED AT A TIME OTHER THAN THE SEEDING SEASON, A TEMPORARY GROUND COVER SUCH AS MULCHING WILL BE USED TO STABILIZE THE BARE SOIL.
- TEMPORARY SEEDING REQUIREMENTS:

SEED: BALBOA RYE AT 150 LBS/AC.
MULCH: STRAW AT 1.5 TON/AC.
ASPHALT: SS-1 OR EQUIVALENT, 150 GAL./AC.
- PERMANENT SEEDING AND SODDING REQUIREMENTS: SEE SPECIFICATIONS.

CHECKLIST FOR REQUIRED INSPECTIONS

YOU MUST NOTIFY THE ENVIRONMENTAL PRESERVATION BRANCH AT 301-694-1132 BEFORE 9 A.M. TWENTY-FOUR HOURS BEFORE THE REQUIRED INSPECTION. FAILURE TO NOTIFY THIS OFFICE WILL RESULT IN A STOP WORK ORDER OR OTHER PENALTIES AS OUTLINED IN THE FREDERICK COUNTY CODES.

NOTICE
THIS LIST IS FOR SEQUENCE OF CONSTRUCTION ONLY. THIS OFFICE ASSUMES NO RESPONSIBILITY OR LIABILITY FOR IMPROPER INSTALLATION OF ANY ITEM ON THIS CHECKLIST. THIS OFFICE RECOMMENDS THAT A PROFESSIONAL ENGINEER BE PRESENT FOR EACH OF THE REQUIRED INSPECTIONS.

TYPE OF INSPECTION	INITIALS
1) PRECONSTRUCTION MEETING	
2) COMPLETION OF SEDIMENT CONTROL MEASURES	
3) PRIOR TO MODIFICATION OR REMOVAL OF SEDIMENT CONTROL	

SEQUENCE OF CONSTRUCTION

- NOTIFY SEDIMENT CONTROL INSPECTOR 24 HOURS PRIOR TO START OF CONSTRUCTION. CALL 301-748-7263 & 301-600-3507 TO CONTACT FREDERICK COUNTY EC FOR PRECONSTRUCTION MEETING.
- PERFORM CLEARING AND GRUBBING REQUIRED FOR INSTALLATION OF PERIMETER CONTROLS.
- INSTALL FILTER LOG AND SCE PER PLAN AND DETAILS. NOTIFY SEDIMENT CONTROL INSPECTOR AND OBTAIN APPROVAL BEFORE PROCEEDING FURTHER.
- UPON TEMPORARY CESSATION OF AN EARTH DISTURBANCE ACTIVITY, THE DISTURBED AREA SHALL BE TEMPORARILY SEEDED.
- INSTALL ALL IMPROVEMENTS, INCLUDING SEDIMENT FOREBAYS, UNDERDRAIN, RIP-RAP, AND ENDWALLS, PER THE CONSTRUCTION PLANS.
- COMPLETE FINAL GRADING, PERMANENT STABILIZATION, NAG C125 LINING, AND LANDSCAPING.
- NOTIFY SEDIMENT CONTROL INSPECTOR AND OBTAIN APPROVAL TO REMOVE SEDIMENT AND EROSION CONTROL DEVICES.

REVISED UTILITY NOTE FOR SECONDARY UTILITY WORK

- ALL DISTURBANCES FROM SECONDARY UTILITY'S SUCH AS PHONE, CABLE, ELECTRIC CABLE, TV CABLE, ETC., WILL BE CONTRACTORS RESPONSIBILITY TO BRING WORK AREA BACK TO GRADE LEVEL THAT WAS EXISTING AND SEED AND MULCH ANY DISTURBANCES FROM INSTALLATION OF LINES OR CONDUIT.
- CONTRACTOR WILL BE RESPONSIBLE FOR RE-INSTALLING OR REPAIRING ANY SILT LOG OR SEDIMENT CONTROLS THAT WERE EXISTING TO MAINTAIN PROPER SEDIMENT CONTROL THAT MIGHT HAVE BEEN DAMAGED.

SOIL STOCKPILE NOTES:

CRITERIA

- THE STOCKPILE LOCATION AND ALL RELATED SEDIMENT CONTROL PRACTICES MUST BE CLEARLY INDICATED ON THE EROSION AND SEDIMENT CONTROL PLAN.
- THE FOOTPRINT OF THE STOCKPILE MUST BE SIZED TO ACCOMMODATE THE ANTICIPATED VOLUME OF MATERIAL AND BASED ON A SIDE SLOPE RATIO NO STEEPER THAN 2:1. BENCHING MUST BE PROVIDED IN ACCORDANCE WITH SECTION B-3 LAND GRADING.
- RUNOFF FROM THE STOCKPILE AREA MUST DRAIN TO A SUITABLE SEDIMENT CONTROL PRACTICE.
- ACCESS THE STOCKPILE AREA FROM THE UPGRADE SIDE.
- CLEAR WATER RUNOFF INTO THE STOCKPILE AREA MUST BE MINIMIZED BY USE OF A DIVERSION DEVICE SUCH AS AN EARTH DIKE, TEMPORARY SWALE OR DIVERSION FENCE. PROVISIONS MUST BE MADE FOR DISCHARGING CONCENTRATED FLOW IN A NON-EROSIVE MANNER.
- WHERE RUNOFF CONCENTRATES ALONG THE TOE OF THE STOCKPILE FILL, AN APPROPRIATE EROSION/SEDIMENT CONTROL PRACTICE MUST BE USED TO INTERCEPT THE DISCHARGE.
- STOCKPILES MUST BE STABILIZED IN ACCORDANCE WITH THE 3/7 DAY STABILIZATION REQUIREMENT AS WELL AS STANDARD B-4-1 INCREMENTAL STABILIZATION AND STANDARD B-4-4 TEMPORARY STABILIZATION.
- IF THE STOCKPILE IS LOCATED ON AN IMPERVIOUS SURFACE, A LINER SHOULD BE PROVIDED BELOW THE STOCKPILE TO FACILITATE CLEANUP. STOCKPILES CONTAINING CONTAMINATED MATERIAL MUST BE COVERED WITH IMPERMEABLE SHEETING.

MAINTENANCE

THE STOCKPILE AREA MUST CONTINUOUSLY MEET THE REQUIREMENTS FOR ADEQUATE VEGETATIVE ESTABLISHMENT IN ACCORDANCE WITH SECTION B-4 VEGETATIVE STABILIZATION. SIDE SLOPES MUST BE MAINTAINED AT NO STEEPER THAN 2:1 RATIO. THE STOCKPILE AREA MUST BE KEPT FREE OF EROSION. IF THE VERTICAL HEIGHT OF A STOCKPILE EXCEEDS 20 FEET FOR 2:1 SLOPES, 30 FEET FOR 3:1 SLOPES, OR 40 FEET FOR 4:1 SLOPES, BENCHING MUST BE PROVIDED IN ACCORDANCE WITH SECTION B-3 LAND GRADING.

BMP INSPECTION & MAINTENANCE

INSPECTION:

REGULAR INSPECTIONS SHALL BE MADE DURING THE FOLLOWING STAGES OF CONSTRUCTION:

- DURING EXCAVATION TO SUBGRADE.
- DURING PLACEMENT OF BACKFILL AND OBSERVATION WELL.
- DURING PLACEMENT OF FILTER FABRIC, SOIL, AND GRAVEL MEDIA.
- DURING CONSTRUCTION OF APPURTENANT CONVEYANCE STRUCTURES.
- UPON COMPLETION OF FINAL GRADING AND ESTABLISHMENT OF PERMANENT STABILIZATION.

MAINTENANCE:

- DURING THE FIRST YEAR OF OPERATION, INSPECT AFTER MAJOR STORMS AND REVEGETATE POORLY ESTABLISHED AREAS.
- SEDIMENT ACCUMULATION ON THE SURFACE SHALL BE REMOVED AND TOP TWO TO THREE INCHES OF SURFACE LAYER REPLACED AS NEEDED.
- THE TOP FEW INCHES OF THE PLANTING SOIL SHALL BE REMOVED AND REPLACED WHEN WATER PONDS FOR MORE THAN 48 HOURS OR THERE IS ALGAL GROWTH ON THE SURFACE.
- IF STANDING WATER PERSISTS AFTER FILTER MEDIA HAS BEEN MAINTAINED, THE GRAVEL, SOIL, AND SAND MAY NEED TO BE CLEANED AND/OR REPLACED.
- OCCASIONALLY PRUNE AND REPLACE DEAD VEGETATION. IF PLANTS ARE NOT SURVIVING RE-PLANT WITH APPROPRIATE SPECIES. WATER AS NEEDED DURING PROLONGED DRY PERIODS.
- MOW AS NEEDED DURING GROWING SEASON TO MAINTAIN HEIGHTS OF AROUND 4-6 INCHES.
- SEDIMENT SHALL BE REMOVED FROM THE FOREBAYS' WHEN FILLED UP TO 50% CAPACITY. SEDIMENT SHALL BE REMOVED FROM THE CHANNEL WHEN IT REACHES 25% CAPACITY.

PERMANENT SEEDING & SODDING

GENERAL

- SCOPE: PLANTING PERMANENT, LONG-LIVED VEGETATIVE COVER ON GRADED OR CLEARED AREAS.
- STANDARDS: PERMANENT SEEDING SHALL CONFORM TO ALL REQUIREMENTS OF "2011 MARYLAND STANDARDS AND SPECIFICATIONS FOR SOIL EROSION AND SEDIMENT CONTROL" PUBLISHED JOINTLY BY WATER RESOURCES ADMINISTRATION, SOIL CONSERVATION SERVICE, AND STATE SOIL CONSERVATION COMMITTEE.

SPECIFICATIONS

- SITE PREPARATION
 - PRIOR TO SEEDING INSTALL ALL REQUIRED SEDIMENT AND EROSION CONTROL MEASURES.
 - FINE GRADING REQUIRED FOR PERMANENT SEEDING.
 - SOIL AMENDMENTS
 - FERTILIZER SHALL BE APPLIED AT THE RATE OF 1000 LBS/ACRE USING 10-10-10 OR EQUIVALENT.
 - SEEDBED PREPARATION
 - SOIL SHALL BE LOOSENED TO A DEPTH OF 3" BY RAKING, DIGGING, OR OTHER ACCEPTABLE MEANS PRIOR TO SEEDING.
 - APPLY SEED UNIFORMLY WITH CYCLONE SEEDER, DRILL, CULTIPACKER SEEDER OR HYDROSEEDER (SLURRY INCLUDES SEED AND FERTILIZER ON A FIRM, MOIST SEEDBED). MAXIMUM SEEDING DEPTH SHOULD BE 1/4" ON CLAYEY SOILS AND 1/2" INCH ON SANDY SOILS, WHEN USING OTHER THAN HYDROSEEDER METHOD OF APPLICATION. NOTE: IF HYDROSEEDING IS USED AND THE SEED FERTILIZER IS MIXED, THEY WILL BE MIXED ON SITE AND THE SEEDING SHALL BE IMMEDIATE WITHOUT INTERRUPTION.
- PERMANENT STABILIZATION WITH SOD**
- ALL SPECIFICATIONS, SITE PREPARATION, INSTALLATION AND MAINTENANCE OF SOD FOR PERMANENT, LONG-LIVED VEGETATIVE COVER SHALL CONFORM TO SECTION G-20 OF "1994" MARYLAND STANDARDS AND SPECIFICATIONS FOR SOIL EROSION AND SEDIMENT CONTROL", PUBLISHED JOINTLY BY WATER RESOURCES ADMINISTRATION, SOIL CONSERVATION SERVICE, AND THE STATE SOIL CONSERVATION COMMITTEE.



PERMANENT SEEDING SUMMARY

SEED MIXTURE (FOR HARDINESS ZONE 6B)					FERTILIZER RATE (10-20-20)			LIME RATE	UREA-FORM (46-0-0)
NO.	SPECIES	APPLICATION RATE (lb/ac)	SEEDING DATES	SEEDING DEPTHS	N	P205	K20		
3	TALL FESCUE	125	3/1 TO 5/15 8/15 TO 10/15	1"-2"					
3	PERENNIAL RYEGRASS	15	3/1 TO 5/15 8/15 TO 10/15	1"-2"	90 lb/ac (2.0 lb/1000 sf)	175 lb/ac (4.0 lb/1000 sf)	175 lb/ac (4.0 lb/1000 sf)	2 tons/ac (100 lb/1000 sf)	
3	KENTUCKY BLUEGRASS	10	3/1 TO 5/15 8/15 TO 10/15	1"-2"				150 lb/ac	

TEMPORARY SEEDING WITH ANNUAL RYEGRASS, MILLET, OATS, AND/OR RYE CONFORMING TO SCS, 1994 MANUAL.

NATIVE DETENTION AREA MIX SEEDING SUMMARY

SEED MIXTURE (FOR HARDINESS ZONE 6B)					FERTILIZER RATE (10-20-20)			LIME RATE	UREA-FORM (46-0-0)
NO.	SPECIES	APPLICATION RATE (lb/ac)	SEEDING DATES	SEEDING DEPTHS	N	P205	K20		
-	ERNMX-183 DEERWALDE 4% VIRGINIA BLUEGRASS 25% FOX SEDGE 20% AUTUMN BENTGRASS 5% TICKLERGRASS 2% PAITH RUSH 1%	22	3/1 TO 5/15 8/15 TO 10/15	1"-2"	NONE	NONE	NONE	NONE	

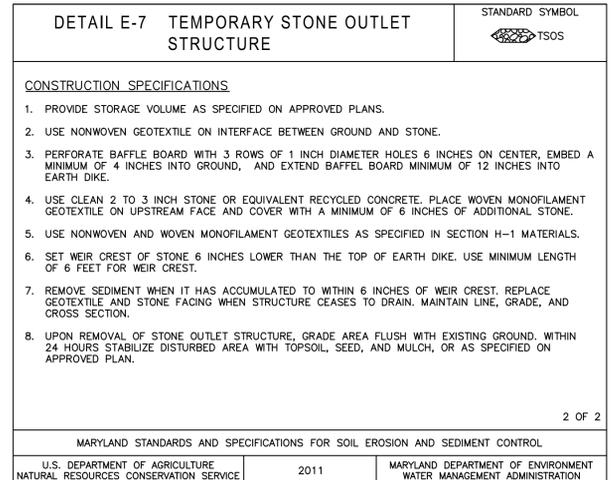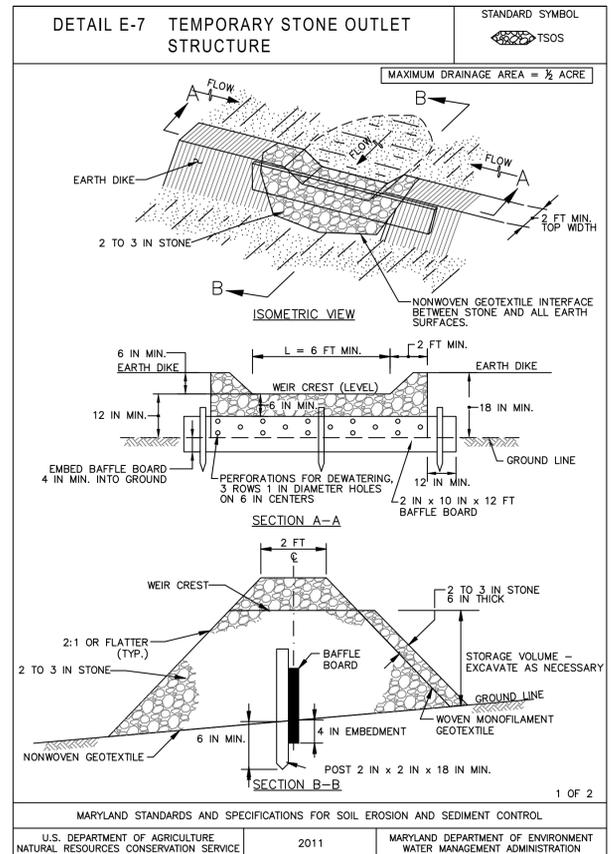

FREDERICK SOIL CONSERVATION DISTRICT
Erosion and Sediment Control Plan Approval

By: _____
District Manager or Designee

Date: _____
Plan is valid for 2 years from date of approval

SCD APPROVAL FOR SEDIMENT AND EROSION CONTROL IS IN ACCORDANCE WITH THE 2011 MARYLAND STANDARDS AND SPECIFICATION FOR SOIL EROSION AND SEDIMENT CONTROL AND IS CONTINGENT UPON ISSUANCE OF APPLICABLE REGULATORY PERMITS.

EDWARD J. VAN ARSDALE, PE DESIGN RELEASED BY			SEAL			SEAL			CLIENT & PROJECT			TITLE		
BCU			CHECKED			TOWN OF WALKERSVILLE 21 WEST FREDERICK STREET WALKERSVILLE, MARYLAND 21793			DEERFIELD BMP RETROFIT EROSION AND SEDIMENT CONTROL NOTES			SCALE		
DRAWN			CHECKED			BMP DESIGNS WALKERSVILLE, FREDERICK COUNTY, MARYLAND			201 Thomas Johnson Drive Suite 207 Frederick, MD 21702 Tel 301.791.1100			AS SHOWN		
CADD			CHECKED			SURVEY DATE			DECEMBER 2022			DWG. NO.		
DATE			JANUARY 2023			FIELD BOOK			WEBER SURVEYORS			S-9		
NO			REVISION			DATE			BY			APP.		
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